
PROJECT FILES\100408 ST JOHNS COUNTY UTILITIES\100408.29 PINE LAKES PS\3 DESIGN\100%\00 GENERAL\DRAWINGS\CADD\G—0.DWG\11/13/2019 ;


ST. JOHNS COUNTY UTILITY DEPARTMENT ST. JOHNS COUNTY, FLORIDA

SJCUD PROJECT NO. 4483-56302-6704-56302

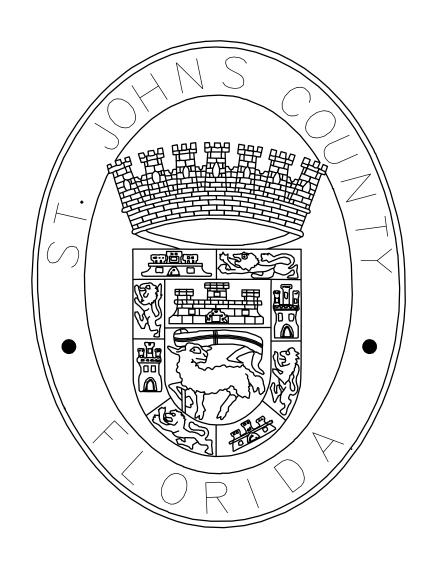



PINE LAKES PUMP STATION UPGRADE PROJECT FEBRUARY 2020

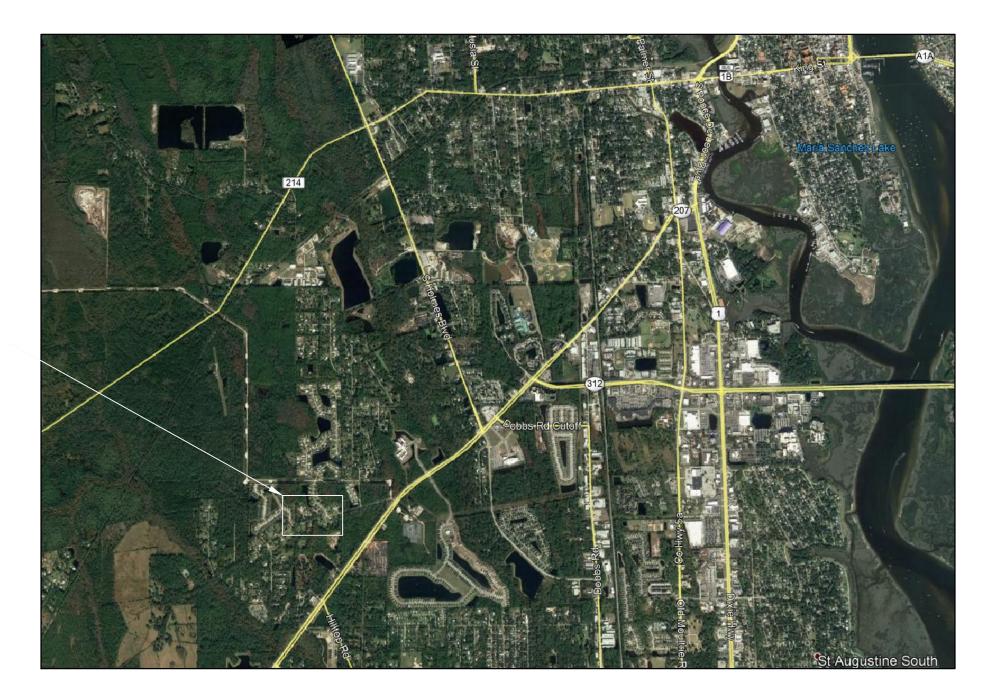

PROJECT LOCATION

1585 Lightsey Road (LS 83)

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ST. JOHNS COUNTY UTILITY DEPARTMENT (SJCUD) GENERAL NOTES

- TWO (2) COPIES OF THE SHOP DRAWINGS (STAMPED APPROVED BY THE ENGINEER) SHALL BE SUBMITTED TO SJCUD FOR REVIEW PRIOR TO SCHEDULING THE MANDATORY PRE-CONSTRUCTION CONFERENCE. THE INITIAL SHOP DRAWING REVIEW BY SJCUD WILL BE COMPLETED WITHIN FIFTEEN (30) WORKING DAYS.
- 2. A PRE-CONSTRUCTION CONFERENCE IS REQUIRED WITH THE ENGINEER OF RECORD, THE UTILITY CONTRACTOR AND THE SJCUD PRIOR THE START OF ANY CONSTRUCTION.
- 3. ALL WATER, SEWER. AND/OR REUSE CONSTRUCTION SHALL BE PERFORMED BY A CONTRACTOR LICENSED UNDER THE PROVISIONS OF CHAPTER 489, FLORIDA STATUTES. A COPY OF THE CONTRACTOR'S GENERAL LICENSE AND/OR UNDERGROUND UTILITY LICENSE SHALL BE PROVIDED AT THE PRE-CONSTRUCTION CONFERENCE.
- 4. THE CONTRACTOR IS RESPONSIBLE FOR INSPECTING THE SITE PRIOR TO CONSTRUCTION.
- 5. THE CONTRACTOR SHALL BE RESPONSIBLE FOR FIELD VERIFICATION OF ALL LOCATIONS & ELEVATIONS PRIOR TO COMMENCEMENT OF CONSTRUCTION.
- 6. THE CONTRACTOR(S) SHALL LOCATE, VERIFY, AND IDENTIFY ALL EXISTING UTILITIES AND UNDERGROUND UTILITIES SHOWN OR NOT SHOWN ON THE PLANS PRIOR TO ANY EXCAVATING ACTIVITIES AND TAKE ALL MEASURES NECESSARY TO PROTECT UTILITIES DURING CONSTRUCTION. SHOULD ANY UTILITY LINE OR COMPONENT BECOME DAMAGED OR REQUIRE RELOCATION, THE CONTRACTOR SHALL IMMEDIATELY NOTIFY THE AFFECTED UTILITY COMPANY, ENGINEER OF RECORD, COUNTY, AND SJCUD.
- 7. THE WATER, SEWER, AND/OR REUSE SYSTEM SHALL BE CONSTRUCTED IN ACCORDANCE WITH THE SJCUD APPROVED CONSTRUCTION DRAWINGS AND SPECIFICATIONS. IF THERE IS ANY DEVIATION FROM THE APPROVED CONSTRUCTION DRAWINGS OR SPECIFICATIONS, WITHOUT PRIOR AUTHORIZATION AND CONSENT FROM THE SJCUD, THE CONTRACTOR SHALL REMOVE THE DEVIATION AND RESTORE IT TO THE APPROVED CONSTRUCTION DRAWING CONFIGURATION AT NO EXPENSE TO THE SJCUD. ANY DEVIATIONS FROM THE APPROVED DOCUMENTS WILL DELAY THE COC SUBMITTAL PROCESS.
- 8. THE CONTRACTOR SHALL FIELD VERIFY THE CONNECTION POINTS PRIOR TO THE COMMENCEMENT OF CONSTRUCTION. ALL DISCREPANCIES SHALL BE REPORTED TO THE ENGINEER OF RECORD AND SJCUD
- 9. SHOULD CONDITIONS VARY FROM THOSE SHOWN ON THESE PLANS, THE CONTRACTOR SHALL IMMEDIATELY NOTIFY THE ENGINEER AND SJCUD PRIOR TO CONTINUING CONSTRUCTION.
- 10. THE CONTRACTOR SHALL PROTECT SURVEY MARKERS, MONUMENTS, ETC. DURING CONSTRUCTION. THE CONTRACTOR SHALL RESTORE/REPLACE, AT NO ADDITIONAL EXPENSE TO THE OWNER, ANY DAMAGE DONE BY CONSTRUCTION ACTIVITIES.
- 11. THE CONTRACTOR SHALL BE RESPONSIBLE FOR ANY DAMAGE TO EXISTING UTILITIES CAUSED BY HIS OPERATIONS. ANY DAMAGE SHALL BE REPLACED/REPAIRED BY THE CONTRACTOR AT NO ADDITIONAL EXPENSE TO THE OWNER.
- 12. THE CONTRACTOR SHALL BE RESPONSIBLE FOR REMOVAL AND DISPOSAL OF ANY UNSUITABLE MATERIAL FROM HIS OPERATION. FURNISHING AND COMPACTING SUITABLE REPLACEMENT BACKFILL MATERIAL SHALL BE IN ACCORDANCE WITH FEDERAL, STATE, AND LOCAL REGULATIONS.
- 13. UNSUITABLE MATERIALS UNDER WATER, SEWER, AND/OR REUSE MAINS SHALL BE REMOVED AND REPLACED WITH SELECTED BACKFILL PROPERLY COMPACTED TO 95% OF MAXIMUM DENSITY. BACKFILL SHALL BE COMPACTED IN A MAXIMUM OF ONE FOOT (1) LIFTS. DENSITY TESTS SHALL BE TAKEN AFTER COMPACTION OF EVERY LIFT.
- 14. THE CONTRACTOR(S) SHALL NOTIFY ALL APPLICABLE UTILITY COMPANIES, THE ENGINEER OF RECORD AND THE PROPERTY OWNER 72 HOURS PRIOR TO INITIATING ANY EXCAVATION ACTIVITIES, OR AS SPECIFIED BY THE UTILITY COMPANIES AND THE PERMITS OBTAINED FOR THE WORK.
- 15. THE ENGINEER OF RECORD AND SJCUD SHALL BE GIVEN SEVENTY TWO HOURS (72-HR) NOTICE OF ALL REQUESTED MEETINGS AND/OR TESTING MEASURES.
- 16. ALL WORK, MATERIALS, AND EQUIPMENT SHALL BE IN COMPLETE ACCORDANCE WITH ALL RELEVANT ST. JOHNS COUNTY STANDARDS AND REQUIREMENTS AS WELL AS STATE AND LOCAL REGULATIONS.
- 17. ALL UNDERGROUND UTILITY EQUIPMENT, MATERIALS AND INSTALLATION SHALL BE IN ACCORDANCE WITH THE LATEST REVISION OF THE MANUAL OF WATER, WASTEWATER. AND REUSE DESIGN STANDARDS & SPECIFICATIONS, ALL APPLICABLE FEDERAL, STATE AND LOCAL REGULATIONS, AND THE APPROVED SITE PLANS.
- 18. ALL ROCK AND UNSUITABLY SIZED STONES (AS DESCRIBED IN APPLICABLE AWWA AND ST. JOHNS COUNTY UTILITIES STANDARDS AND/OR PIPE MANUFACTURER'S RECOMMENDED INSTALLATION PROCEDURES FOUND IN TRENCHES FOR NEW AND RELOCATED PIPE SHALL BE REMOVED TO A DEPTH OF AT LEAST SIX (6) INCHES BELOW THE BOTTOM OF THE PIPE. CONTINUOUS AND UNIFORM BEDDING SHALL BE PROVIDED FOR NEW AND RELOCATED PIPES. THE BACKFILL MATERIAL SHALL BE TAMPED IN LAYERS AROUND THE NEW AND RELOCATED PIPES AND TO A SUFFICIENT HEIGHT ABOVE SUCH PIPE TO ADEQUATELY SUPPORT AND PROTECT THE PIPE.
- 19. FOR WATER, WASTEWATER, AND REUSE MAINS SMALLER THAN 12 INCHES, THE MINIMUM COVER SHALL BE 36
- 20. FITTINGS SHALL BE USED AT LOCATIONS INDICATED ON THE PLANS, UNLESS OTHERWISE APPROVED BY THE ENGINEER. ALL FITTINGS SHALL BE RESTRAINED.
- 21. ALL UNDERGROUND VALVES SHALL BE INSTALLED WITH AN ADJUSTABLE CAST IRON VALVE BOX WITH THE TOP SET TO FINAL GRADE IN ACCORDANCE TO SJCUD DETAILS AND SPECIFICATIONS. ALL VALVES SHALL HAVE PEG LOCATORS (145.7 KILOHERTZ).
- 22. CONTRACTOR IS RESPONSIBLE FOR PROPER NOTIFICATION OF INSPECTING AUTHORITIES BEFORE AND DURING
- 23. CONTRACTOR SHALL PROVIDE A MINIMUM OF SEVEN (7) CALENDAR DAYS NOTICE TO SJCUD PRIOR TO SCHEDULING THE FINAL INSPECTION.
- 24. TIE-IN WORK OR SHUTDOWNS SHALL NOT OCCUR ON FRIDAYS.
- 25. A MAXIMUM OF 4 HOURS IS ALLOWED FOR PUMP STATION SHUTDOWN. THE CONTRACTOR SHALL COORDINATE SHUTDOWNS WITH SJCUD AND PROVIDE A MINIMUM OF 48 HOURS NOTICE.

POTABLE WATER SYSTEMS NOTES:

- 1. ALL WATER LINES 2" DIAMETER OR LESS SHALL BE PEX, CTS, SDR 9, COLOR "BLUE".
- 2. ALL CURB STOPS ARE TO BE FORD BALL-TYPE OR EQUAL WITH LOCKING CAPACITY. 1" MINIMUM.
- 3. THE SEPARATION REQUIREMENT BETWEEN POTABLE WATER MAINS AND OTHER UTILITIES SHALL BE PER CH. 62-555, FAC.
- 4. WHERE SOLVENT CONTAMINATION IS FOUND IN THE TRENCH, WORK WILL BE STOPPED AND THE PROPER AUTHORITIES NOTIFIED. WITH THE APPROVAL OF THE ST. JOHNS COUNTY HEALTH DEPARTMENT, DUCTILE IRON PIPE, FITTINGS AND APPROVED SOLVENT RESISTANT GASKET MATERIAL SHALL BE USED IN THE CONTAMINATED AREA. THE DUCTILE IRON PIPE WILL EXTEND AT LEAST 100 FEET BEYOND ANY DISCOVERED CONTAMINATION.
- 5. NO CONNECTION TO EXISTING POTABLE WATER SYSTEM SHALL BE ALLOWED UNTIL ALL PROPOSED WATER LINES HAVE BEEN PRESSURE TESTED, DISINFECTED, CLEARED FOR SERVICE AND ACCEPTED FOR MAINTENANCE BY THE

SJCUD AND FDEP.

AND RULE 62-555.340, FAC.

- 6. JUMPER CONNECTIONS WITH BACKFLOW PREVENTION DEVICE SHALL BE USED TO FILL OR FLUSH WATER MAINS
- 7. ALL NEW AND RELOCATED WATER MAIN PIPE, FITTINGS, VALVES, AND FIRE HYDRANTS SHALL BE IN CONFORMANCE WITH APPLICABLE AMERICAN WATER WORKS ASSOCIATION (AWWA) AND SJCUD STANDARDS.
- 8. ALL NEW AND RELOCATED WATER MAIN PIPE AND FITTINGS WILL COMPLY WITH THE LATEST FDEP AND AWWA STANDARDS FOR LEAD CONTENT.
- 9. ALL NEW AND RELOCATED WATER MAINS SHALL BE PRESSURE TESTED AND LEAKAGE TESTED IN ACCORDANCE WITH AWWA STANDARD C605, LATEST EDITION.
- 10. ALL NEW AND RELOCATED WATER MAINS SHALL BE DISINFECTED IN ACCORDANCE WITH AWWA STANDARD C651
- 11. ALL NEW AND RELOCATED WATER SERVICES SHALL BE IN CONFORMANCE WITH THE STATE PLUMBING CODE AND SJCUD STANDARDS.
- 12. THE BACTERIOLOGICAL SAMPLE POINTS SHALL BE INDICATED ON THE AS BUILT DRAWINGS, THE SAMPLE POINT NUMBERING AND STATIONING SHALL CORRESPOND TO THOSE ON THE BACTERIOLOGICAL SAMPLE CHAIN OF CUSTODY FORMS.

WASTEWATER SYSTEM NOTES:

I. INTERIOR LINERS SHALL BE SPECTRASHIELD OR EQUAL AS APPROVED BY SJCUD.

2. SANITARY SEWER FORCE MAIN 4" AND LARGER SHALL BE C900 DR25 PVC PIPE CONFORMING TO ASTM D-1784, D-1785, AND D-2241. DUCTILE IRON PIPE SHALL ONLY BE USED WITH PRIOR APPROVAL BY THE SJCUD. SANITARY FORCE MAIN SHALL BE COLOR CODED GREEN AND CLEARLY MARKED.

- 1. IT SHALL BE THE CONTRACTOR'S RESPONSIBILITY TO PRODUCE, SUBMIT AND OBTAIN APPROVAL OF REPRODUCIBLE "AS-BUILT" DRAWINGS FROM JURISDICTIONAL AGENCIES AS MAY BE REQUIRED.
- 2. "AS-BUILT" INFORMATION SHALL BE THE RESPONSIBILITY OR THE CONTRACTOR, CONTRACTOR SHALL EMPLOY THE SERVICES OF A SURVEYOR REGISTERED IN THE STATE OF FLORIDA TO DETERMINE ALL "AS-BUILT" INFORMATION. UPON COMPLETION OF THE WORK, THE CONTRACTOR SHALL PROVIDE UP TO SIX COPIES AND THE CAD FILE OF AS-BUILT DRAWINGS TO THE ENGINEER.
- 3. A MINIMUM OF FIVE WORKING DAYS PRIOR TO THE FINAL INSPECTION, TWO (2) SETS OF PRELIMINARY BLACKLINE "AS-BUILTS" AND COPY ON DISK IN AUTOCAO FORMAT SHOWING THE REQUIRED INFORMATION, SHALL BE SUBMITTED TO THE ENGINEER OF RECORD.
- 4. THE RECORD OR "AS BUILT" DRAWINGS TO BE PREPARED BY THE CONTRACTOR AND SUBMITTED AT THE TIME OF THE REQUEST FOR FINAL COMPLETION TO PLACE THE CONSTRUCTION INTO SERVICE WILL CLEARLY DEPICT THE VERTICAL CLEARANCES BETWEEN WATER, SEWER (INCLUDING STORM) AND REUSE LINES AT ALL CROSSING AND PARALLEL RUNS WHERE THE HORIZONTAL SEPARATION IS LESS THAN 10 FEET. IN ADDITION, THE CENTERING OF UNCUT LENGTHS OF PIPE (USUALLY 20 FEET) AT POINTS OF CROSSINGS WILL BE DOCUMENTED ON THE DRAWINGS AND ALL MITIGATING CONSTRUCTION MEASURES CLEARLY DEPICTED IN CASES WHERE A MINIMUM OF 18 INCHES OF VERTICAL CLEARANCE BETWEEN THE WATER AND SEWER (INCLUDING STORM) LINES IS NOT POSSIBLE.
- 5. AFTER SJCUD HAS APPROVED PRELIMINARY "AS BUILT", THREE (3) SETS OF BLACKLINE AS-BUILTS (SIGNED AND SEALED), ONE SET OF MYLARS AS BUILT (SIGNED), AND COPY ON DISK IN AUTOCAD FORMAT SHOWING THE REQUIRED INFORMATION, SHALL BE SUBMITTED TO SJCUD.

HYDROSTATIC TESTING NOTE


I. AFTER ALL PRESSURE PIPES ARE INSTALLED, THE JOINTS COMPLETED, AND THE TRENCH BACKFILLED, THE NEWLY LAID PIPE AND APPURTENANCES SHALL BE SUBJECTED TO A HYDROSTATIC TEST FOR A PERIOD OF AT LEAST TWO (2) HOURS. THE ENGINEER AND THE SJCUD MUST BE NOTIFIED AT LEAST 72 HOURS BEFORE A TEST IS TO BE PERFORMED. TEST SHALL BE AS SET FORTH IN AWWA STANDARD C605. ANY LEAKS DETECTED SHALL BE CORRECTED AND THE SECTION OF PIPELINE RETESTED. THE TWO HOUR TEST PERIOD SHALL BEGIN WHEN ALL JOINTS HAVE BEEN DETERMINED TO BE WATER TIGHT. LEAKAGE SHALL BE LIMITED TO THAT ALLOWANCE SET FORTH IN SECTION 4 OF AWWA STANDARD C600 LATEST EDITION. HYDROSTATIC AND LEAKAGE TEST AND BLOW-DOWN (ZEROING OF GAGE) MUST OCCUR BEFORE SAMPLING FOR BACTERIOLOGICAL TEST. THE MAXIMUM ALLOWABLE PRESSURE LOSS IS 5 PSI.

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		BY	DATE	SYMBOL	REVISIONS	DESIGNER:	DAR	DES
L	6. 5.					DRAWN BY:	RRP	
						OUEOKED DV	550	
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L	3. 2.					APPROVED BY:	DAR	
	2.							
	1.		RRP			DATE:	FEBRUARY 2020	
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SIGN ENGINEER

ORIDA REGISTRATION NO



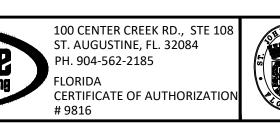

PINE LAKES PUMP STATION UPGRADE PROJECT

GENERAL NOTES

PROJECT NO. 100408.2 FILE NAME

TABLE OF ABBREVIATIONS → BENCHMARK ● - SET 1/2" IRON PIPE, LB 6824 ● - FOUND 1/2" IRON PIPE AS NOTED \blacksquare - FOUND 4"x4" CONCRETE MONUMENT, NO I.D. – MAG NAIL P(GS) – PAGE, PAGES Ì.D. – IDENTIFICAITON R/W - RIGHT OF WAY C.B. — CHORD BEARING AND DISTANCE R – RADIUS D - DELTA ANGLE _ ARC LENGTH PC - POINT OF CURVE MOOD 🗘 – UTILITY POLE · – UTILITY POLE → – GUY ANCHOR OHE — OVERHEAD ELECTRIC STORK -- − SIGN ECB — ELECTRIC CONTROL CABINET **-Ò-** − FIRE HYDRANT ◯ – VENT --- SANITARY MANHOLE: AVENUE TOP=34.09 8" PVC N INVERT=27.49 ₩- TREE 8" PVC W INVERT=27.44 8" PVC E INVERT=28.89 — UE — UE — UE — UE — UNDERGROUND ELECTRIC — 4" DISCHARGE PIPING --- wL ---- wL ---- wL --- -WATER LINE WET WELL: TOP=35.32 — UT — UT — UT — — TELEPHONE LINE 8" PVC E INVERT=27.02 — FM — FM — FM — FORCE MAIN BOTTOM=24.77 — FOC — FOC — FOC — FOC — FIBER OPTIC CABLE BRADSHAW-NILES & ASSOCIATES, INC. SURVEYING AND MAPPING CONSULTANTS LICENSED BUSINESS NO. 6824 280 BUSINESS PARK CIRCLE, SUITE 410 BNA ST. AUGUSTINE, FLORIDA 32095 (904) 829-2591 FAX: (904) 829-5070 CERTIFIED TO: THIS SURVEY IS CERTIFIED FOR THE EXCLUSIVE USE OF THE CLIENT NAMED HEREON AND IS NOT VALID WITHOUT THE SIGNATURE AND RAISED SEAL OF THE PROFESSIONAL SURVEYOR AND MAPPER OF FLORIDA SHOWN HEREON. DRAWN BY: A.D.B. & T.C.H. CHECKED BY: A.D.B. FIELD BOOK/PAGE(S): 395/41-43B, 395/72,74,77 REV DATE BY CKD DESCRIPTION GENERAL NOTES:
1. ALL COORDINATES AND BEARINGS SHOWN HEREIN ARE REFERENCED TO THE FLORIDA STATE PLANE COORDINATE SYSTEM, NORTH AMERICAN DATUM OF 1983—1990 ADJUSTMENT (N.A.D. 83/90) FOR THE EAST ZONE OF THE STATE OF FLORIDA, TRANSVERSE MERCATOR PROJECTION AND BASED ON NATIONAL GEODETIC SURVEY CONTROL POINTS AS FOLLOWS: PROJECTION AND BASED ON NATIONAL GEODETIC SURVEY CONTROL POINTS AS FOLLOWS:

"JACKSONVILLE CORS ARP"

N 30'29'02.515"

N 29'41'11.557"

W 081'42'05.330"

SCALE FACTOR CONVERGENCE=0.99999711

SCALE FACTOR CONVERGENCE=0.99996288

(THIS IS A GPS CONTINUOUSLY OPERATING REFERENCE STATION)

BEARINGS BASED ON THE NORTHERLY LINE OF SECTION 35, AS BEING SOUTH 89'47'44" EAST.

THIS SURVEY WAS CONDUCTED FOR THE PURPOSE OF A BOUNDARY SURVEY ONLY AND IS NOT INTENDED TO DELINEATE THE REGULATORY JURISDICTION OF ANY FEDERAL, STATE, REGIONAL OR LOCAL AGENCY, BOARD, COMMISSION OR OTHER ENTITY.


NOT ABSTRACTED FOR EASEMENTS. NO ABSTRACT OF TITLE FURNISHEY. 4. ALL ELEVATIONS ARE IN N.A.V.D. 88 AND ARE BASED IN U.S. SURVEY FEET. PRIMARY BENCHMARK "SJC 1000" ELEVATION=36.83" THIS SURVEY MEETS THE STANDARDS OF PRACTICE FOR PROFESSIONAL SURVEYORS AND MAPPERS PURSUANT TO CHAPTERS 5J-17.051 & 5J-17.052 F.A.C. ALBERT D. BRADSHAW, P.S.M., FLORIDA CERTIFICATION NO. 5257 NO BY DATE SYMBOL REVISIONS DESIGNER: DESIGN ENGINEER PROJECT NO. 100 CENTER CREEK RD., STE 108 ST. JOHNS COUNTY PINE LAKES PUMP STATION UPGRADE PROJECT ST. AUGUSTINE, FL. 32084 DRAWN BY: KWS DAVID A. RASMUSSEN P.E FILE NAME Constantine **UTILITY DEPARTMENT** PH. 904-562-2185 CHECKED BY: DRS SHEET NO. LORIDA REGISTRATION NO. EXISTING SITE SURVEY AND PLAN 1205 STATE ROAD 16 APPROVED BY: DAR ST AUGUSTINE, FLORIDA 32084-8646


CERTIFICATE OF AUTHORIZATION

FEBRUARY 2020

Phone (904) 209-2700 • Fax. (904) 209-2702

ISSUED FOR BID

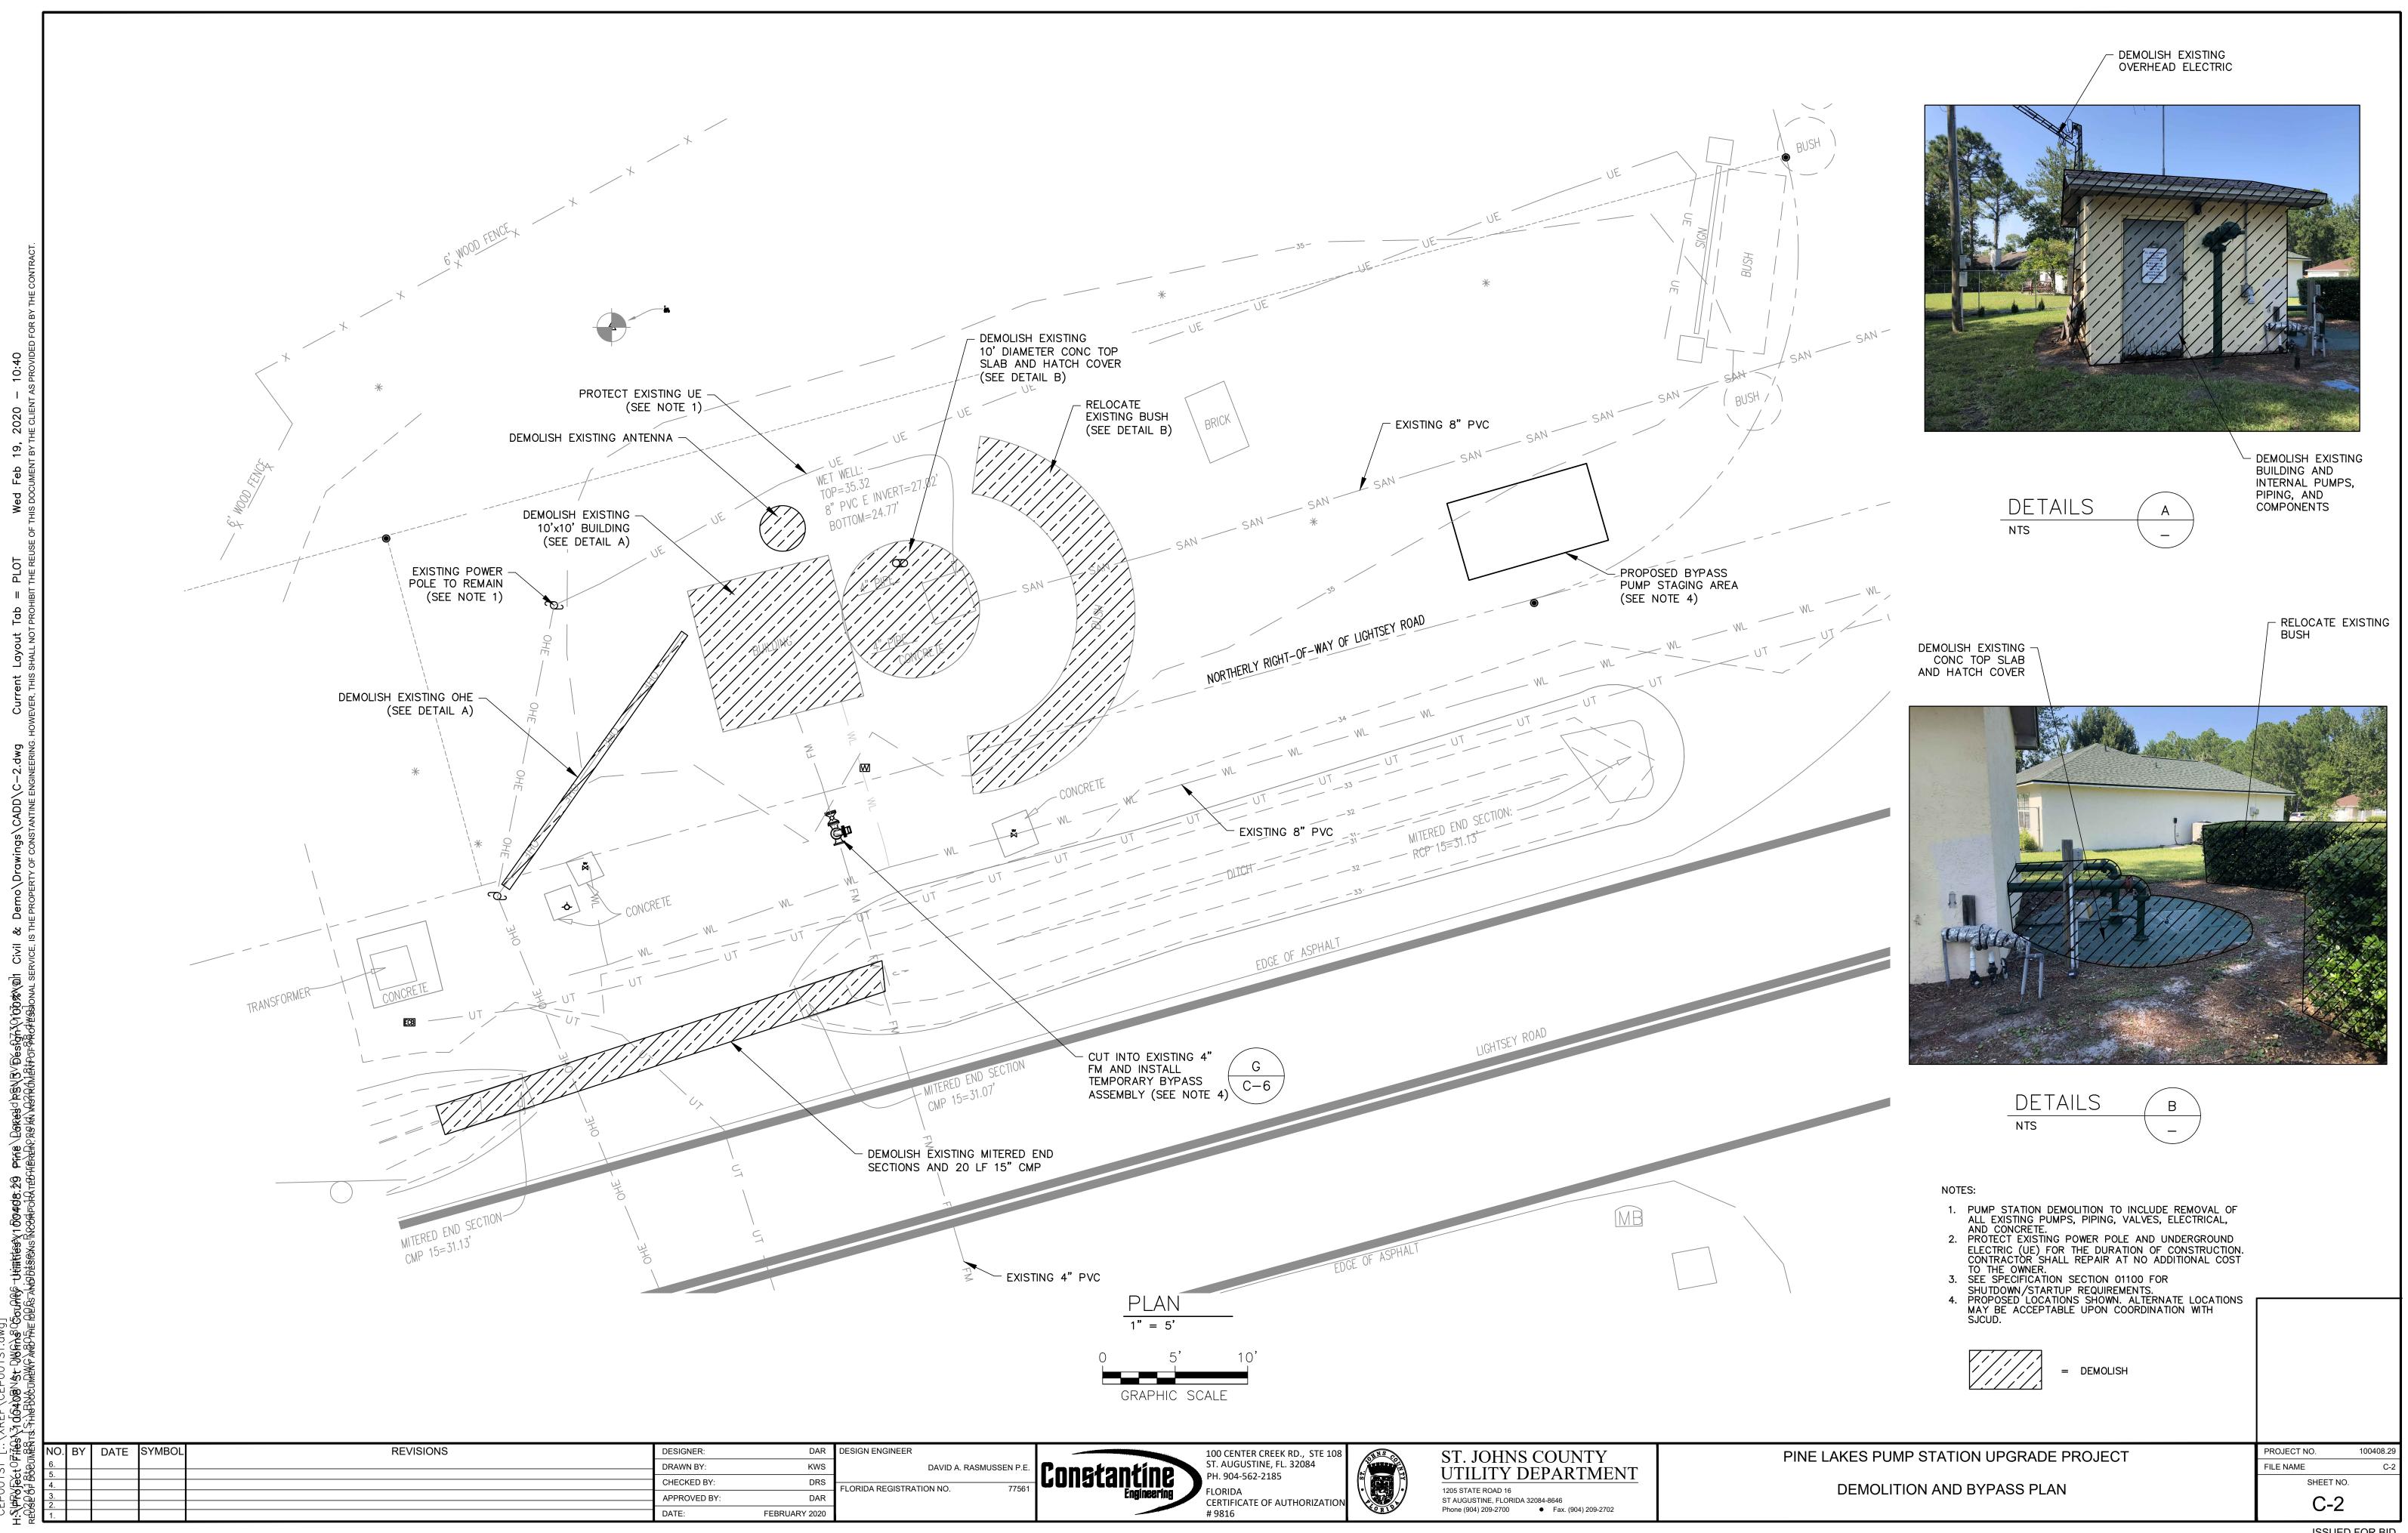

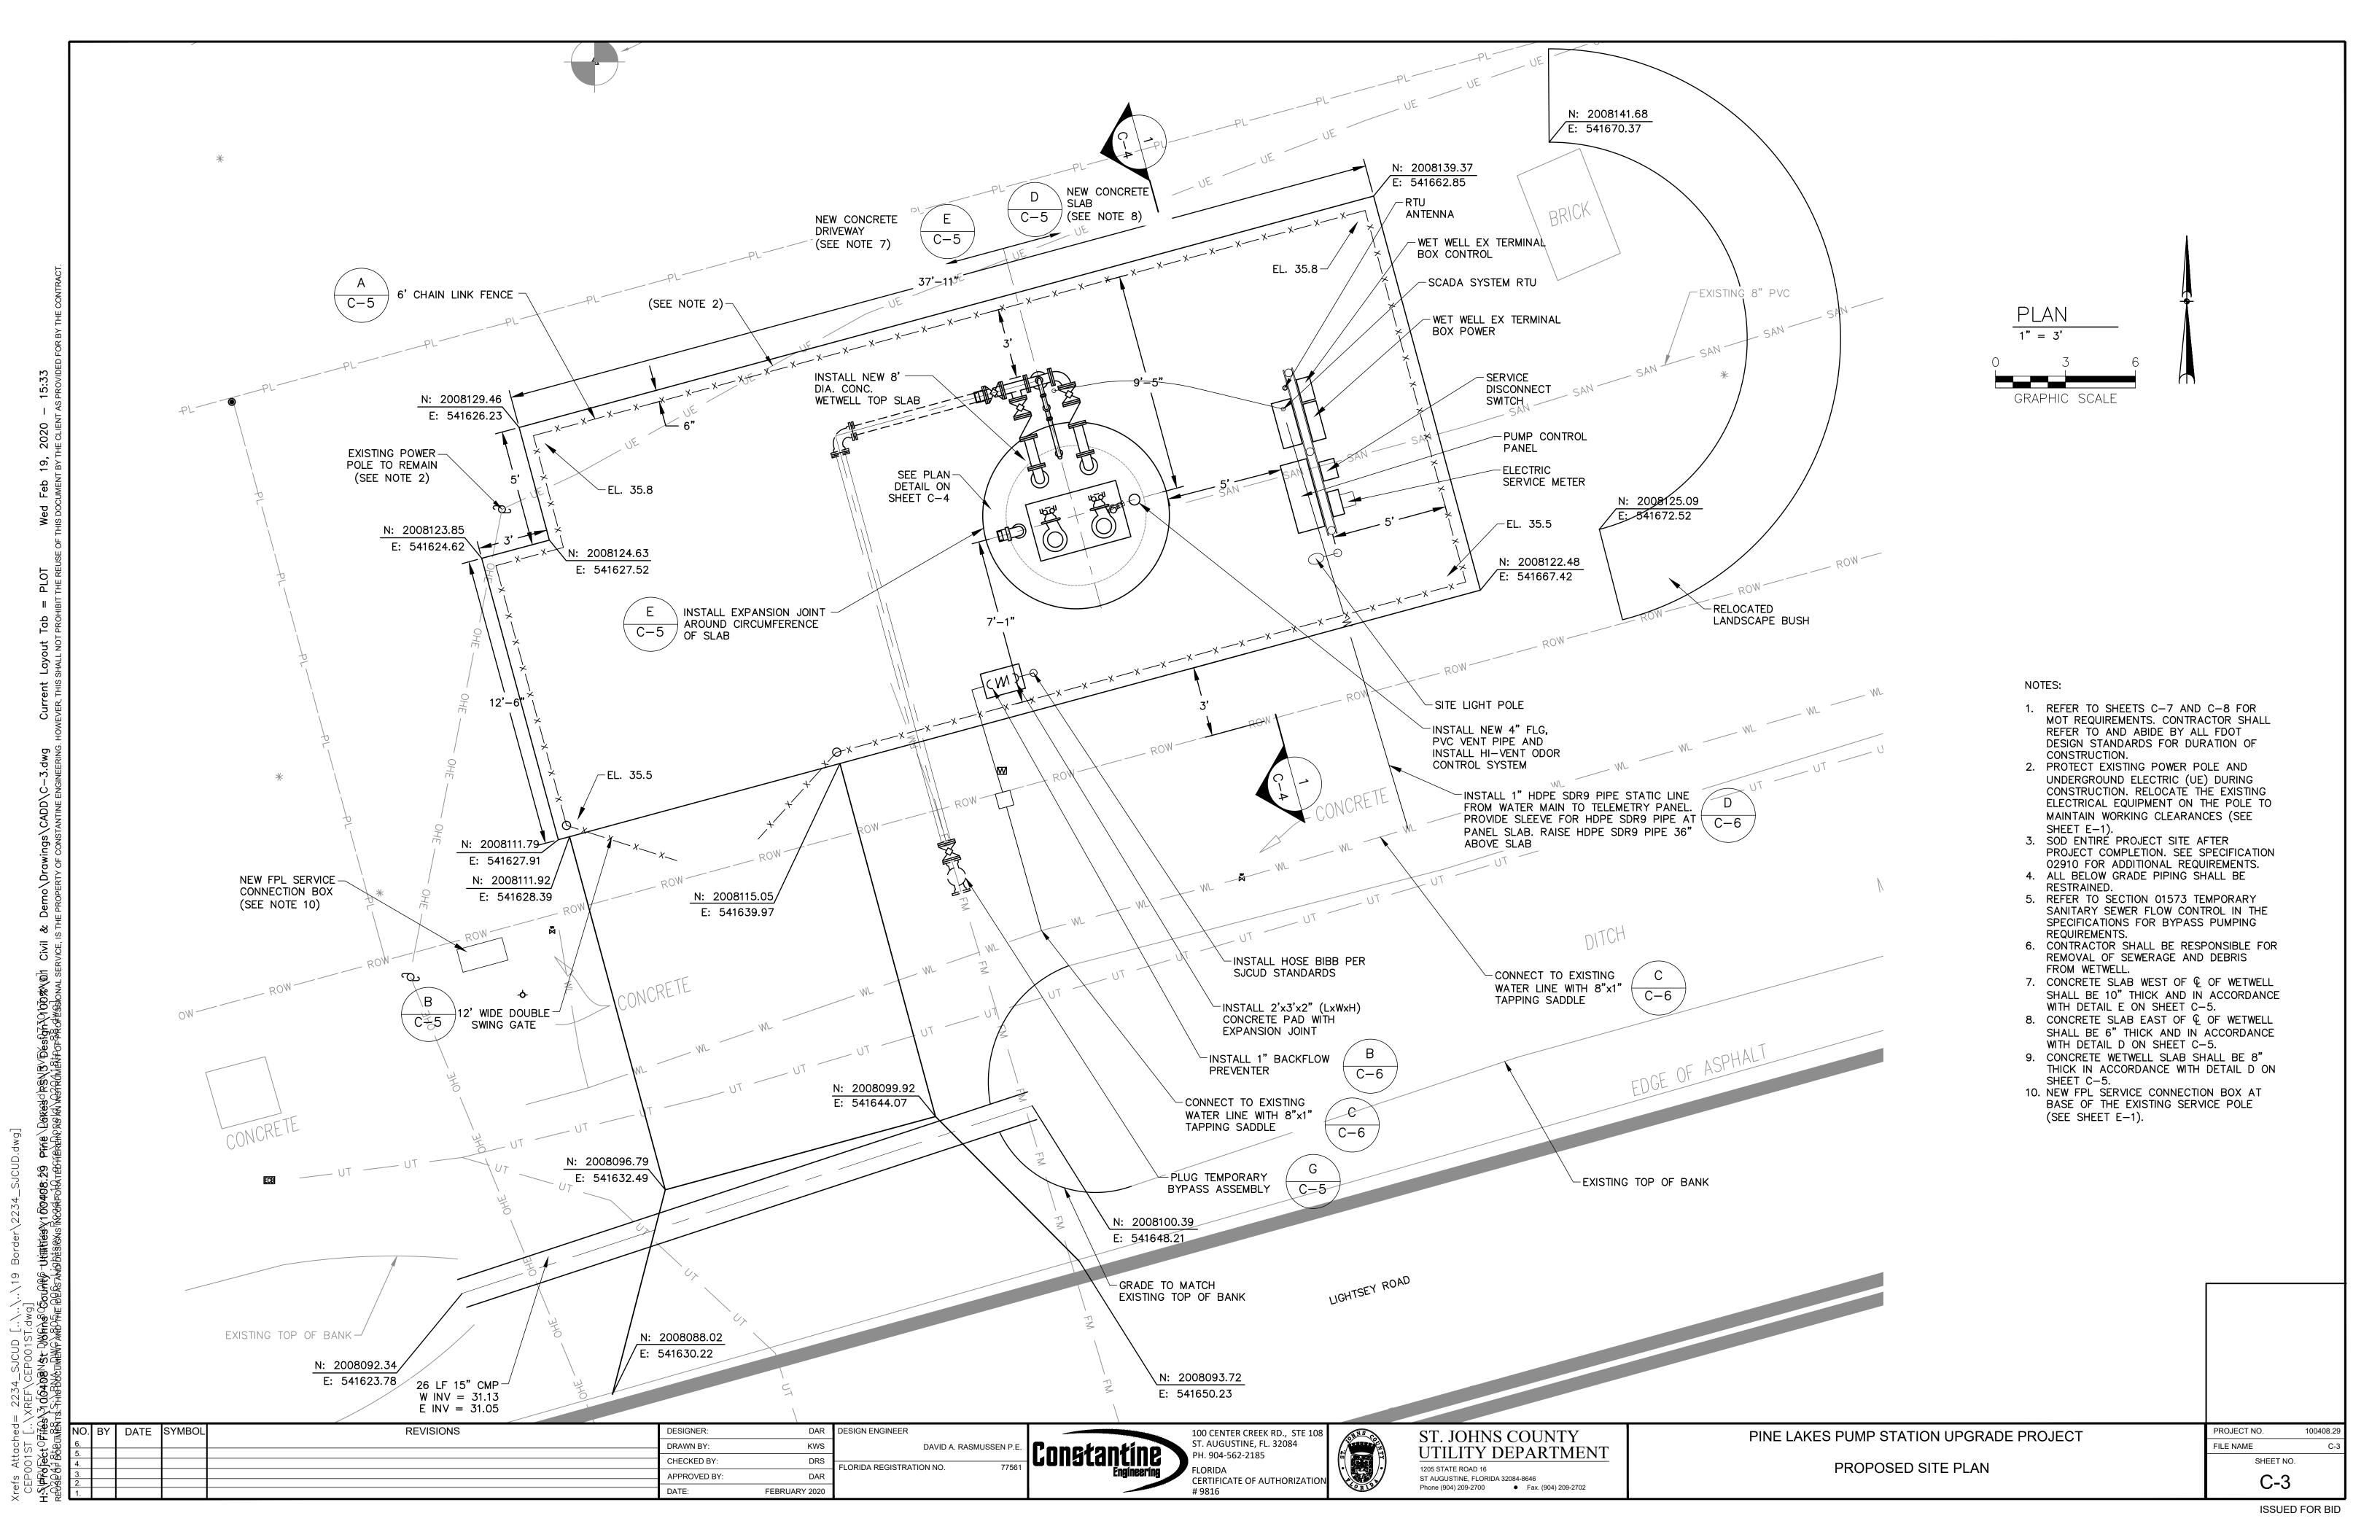

(J) (2) 4" FLANGED —

4" SCH 40 316 SS EMERGENCY

SUCTION SUCTION PIPING W/ 90°

BEND & 4" KAMLOCK FITTING

(TYP. OF 2)

PLUG VALVE (TYP. OF 2)

4" FLANGED SPRING -


AND LEVER CHECK VALVE

5" DIAMETER OPENING


EXISTING 6' DIA. WETWELL

WETWELL TOP SLAB

INSTALL NEW 8' DIA. CONC.

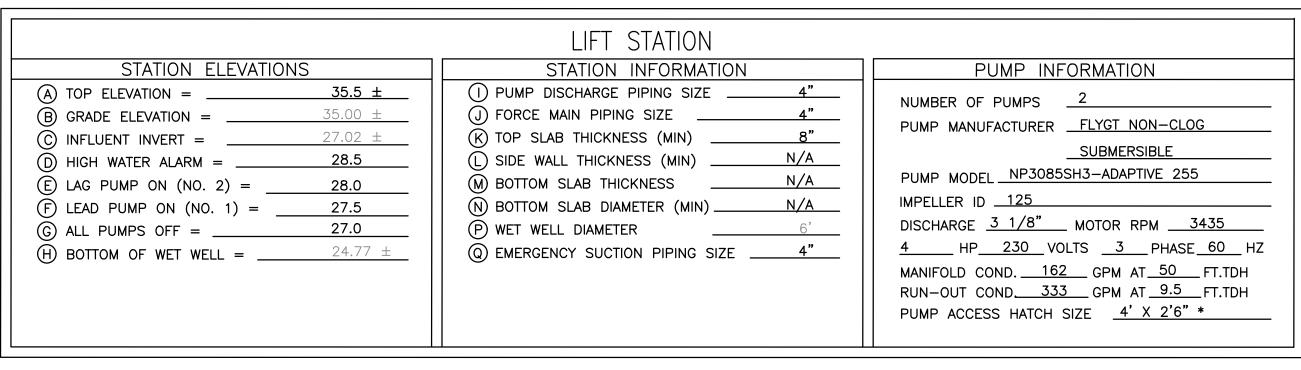

* TO BE CONFIRMED BY THE PUMP MANUFACTURER

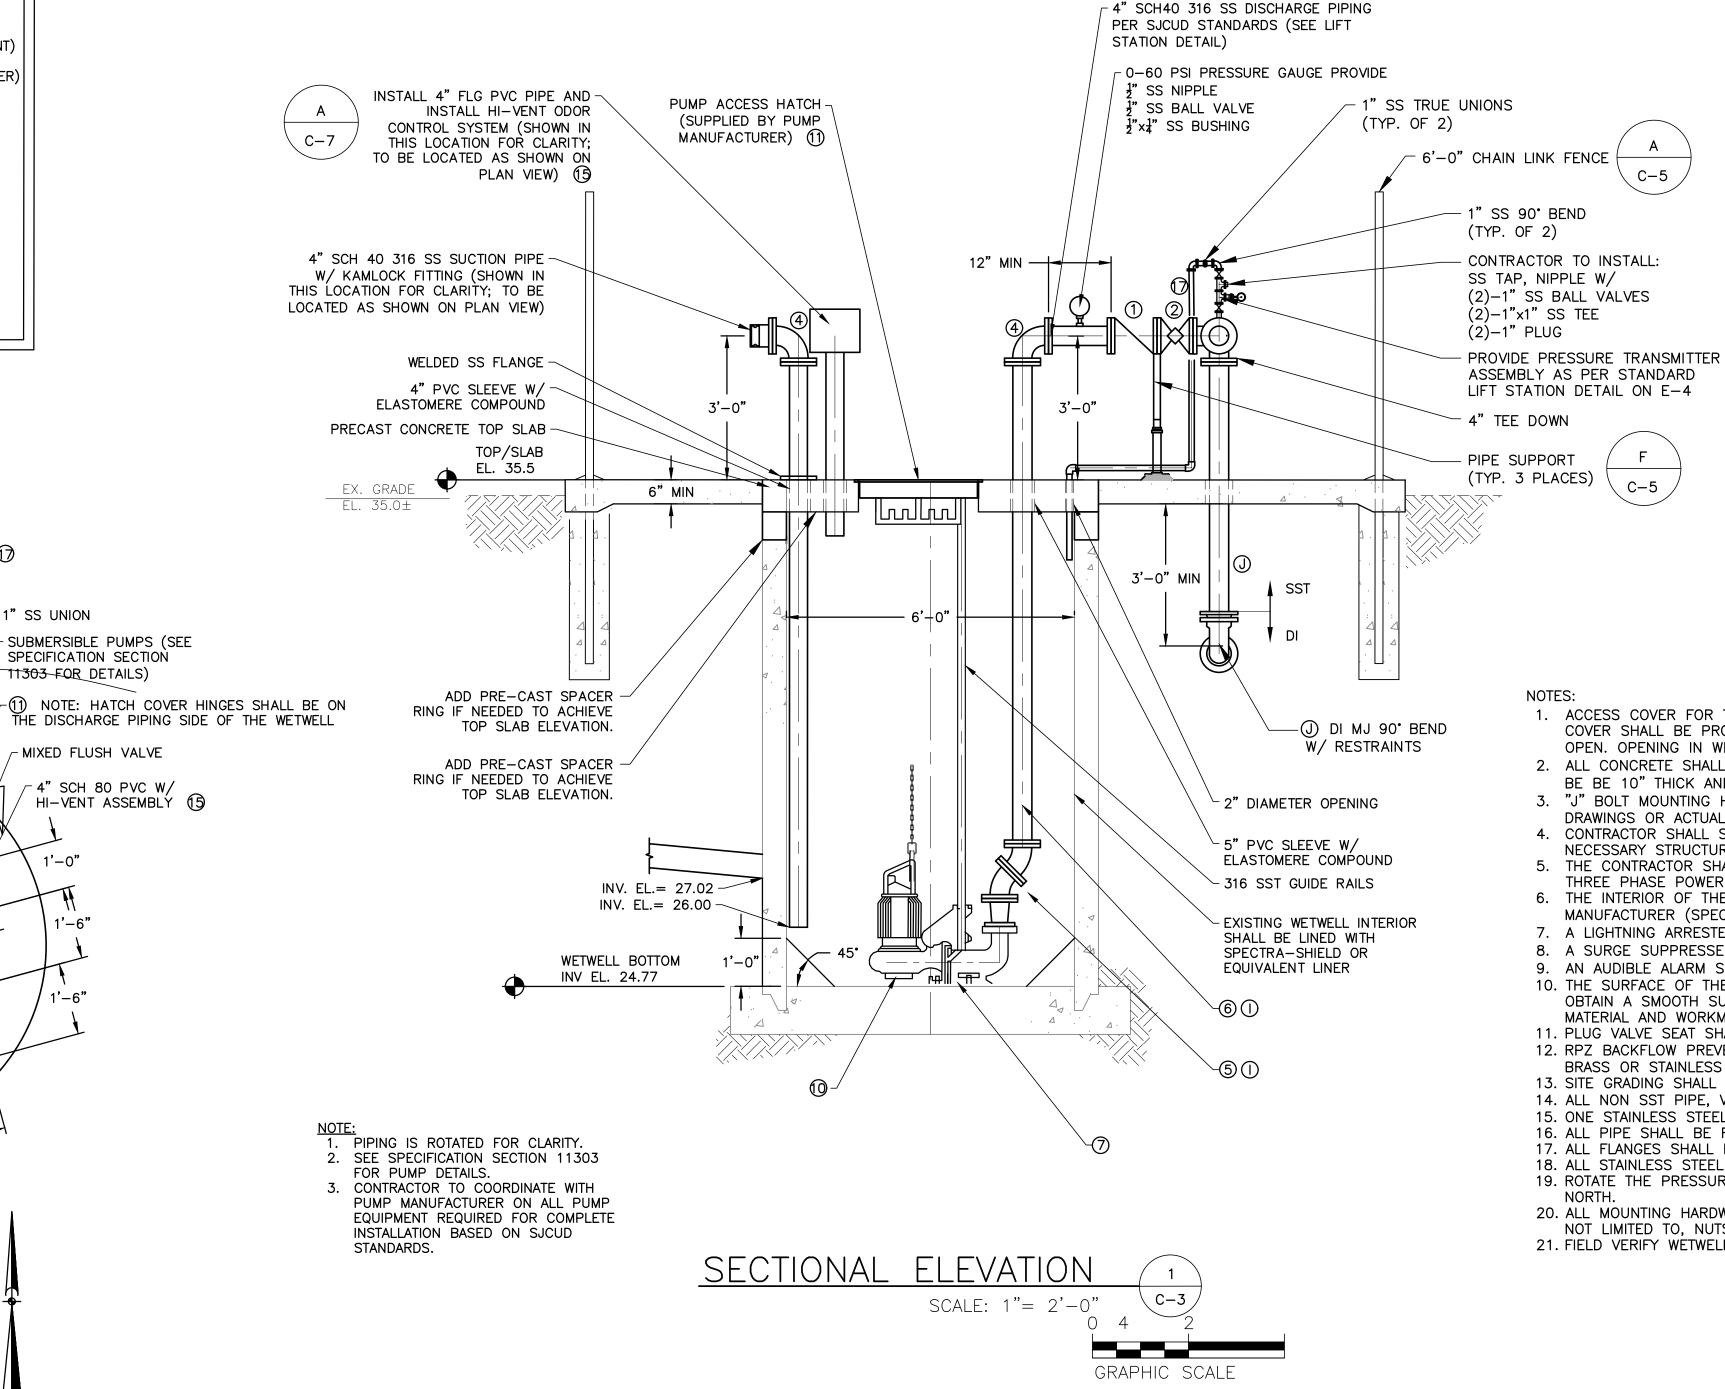

NOTES: ACCESS COVER FOR THE WETWELL SHALL BE $\frac{1}{4}$ " ALUM. TREAD PLATE WITH STAINLESS STEEL HARDWARE. COVER SHALL BE PROVIDED WITH LIFTING HANDLE. LCOKING HASP AND SAFETY LATCH TO HOLD COVERS OPEN. OPENING IN WETWELL SLAB AS PER MANUFACTURER'S SPECIFICATIONS.

2. ALL CONCRETE SHALL BE 6" THICK AND REINFORCED WITH 6x6 10/10 WWM EXCEPT DRIVEWAY WHICH SHALL BE BE 10" THICK AND WETWELL COVER WHICH SHALL BE 8" THICK.

3. "J" BOLT MOUNTING HOLE AND CONDUIT HOLES SHALL BE CORE DRILLED IN THE FIELD AS PER SHOP DRAWINGS OR ACTUAL FIELD REQUIREMENTS.

4. CONTRACTOR SHALL SUBMIT SHOP DRAWINGS OF PRECAST WETWELL. SHOP DRAWINGS SHALL INCLUDE ALL NECESSARY STRUCTURAL AND FLOTATION CALCULATIONS.

5. THE CONTRACTOR SHALL BE RESPONSIBLE FOR FURNISHING ELECTRICAL POWER TO THE PUMPING STATION. THREE PHASE POWER IS REQUIRED. THIS WORK IS TO BE COORDINATED WITH FLORIDA POWER AND LIGHT.

6. THE INTERIOR OF THE WET WELL AND RECEIVING MANHOLE SHALL BE COATED WITH LINER BY APPROVED MANUFACTURER (SPECTRASHIELD, RAVEN, OR GREEN MONSTER).

7. A LIGHTNING ARRESTER SHALL BE SUPPLIED AND INSTALLED BY THE "SYSTEM" SUPPLIER. 8. A SURGE SUPPRESSER SHALL BE SUPPLIED AND INSTALLED BY THE "SYSTEM" SUPPLIER.

9. AN AUDIBLE ALARM SHALL BE SUPPLIED AND INSTALLED BY THE "SYSTEM" SUPPLIER.

10. THE SURFACE OF THE WET WELL SHALL FIRST BE PREPARED BY GROUTING THE WET WELL AS REQUIRED TO

OBTAIN A SMOOTH SURFACE. THE COATING SHALL BE WARRANTED FOR A MINIMUM OF 10 YEARS FOR MATERIAL AND WORKMANSHIP.

11. PLUG VALVE SEAT SHALL BE INSTALLED ADJACENT TO CHECK VALVE REGARDLESS OF FLOW ARROW ON VALVE. 12. RPZ BACKFLOW PREVENTER (WILKINS MO. 975XL2) PIPING ABOVE GRADE SHALL BE THREADED BRASS WITH BRASS OR STAINLESS STEEL FITTING AND VALVES.

13. SITE GRADING SHALL PROVIDE FOR DRAINAGE OF WATER TO THE DRIVEWAY SIDE OF SITE. 14. ALL NON SST PIPE, VALVES, AND FITTINGS SHALL BE PAINTED FOREST GREEN (OIL BASED).

15. ONE STAINLESS STEEL SUPPORT SHALL BE INSTALLED UNDER EACH PLUG VALVE.

16. ALL PIPE SHALL BE FLANGED STAINLESS STEEL.

17. ALL FLANGES SHALL BE 150LB SLIP FLANGES.

18. ALL STAINLESS STEEL MUST BE SCHEDULE 40.

19. ROTATE THE PRESSURE TRANSMITTER MOUNTING TEE SUCH THAT THE PRESSURE TRANSMITTER DISPLAY FACES

20. ALL MOUNTING HARDWARE SHALL BE 316 STAINLESS STEEL WITH ANTI-FREEZE COMPOUND INCLUDING, BUT

NOT LIMITED TO, NUTS, BOLTS, AND BRACKETS. 21. FIELD VERIFY WETWELL FLOAT ELEVATIONS.

NO. BY DATE SYMBOL **REVISIONS** DESIGNER: DRAWN BY CHECKED BY

SCALE: 1"= 2'-0"

GRAPHIC SCALE

DESIGN ENGINEER DAR **KWS** DAVID A. RASMUSSEN P.E DRS ORIDA REGISTRATION NO. APPROVED BY DAR FEBRUARY 2020




100 CENTER CREEK RD., STE 10 T. AUGUSTINE, FL. 32084 H. 904-562-2185 **CERTIFICATE OF AUTHORIZATIO**




PINE LAKES PUMP STATION UPGRADE PROJECT


LIFT STATION PLAN, SECTION, AND DETAILS


PROJECT NO. 100408.29 FILE NAME SHEET NO.

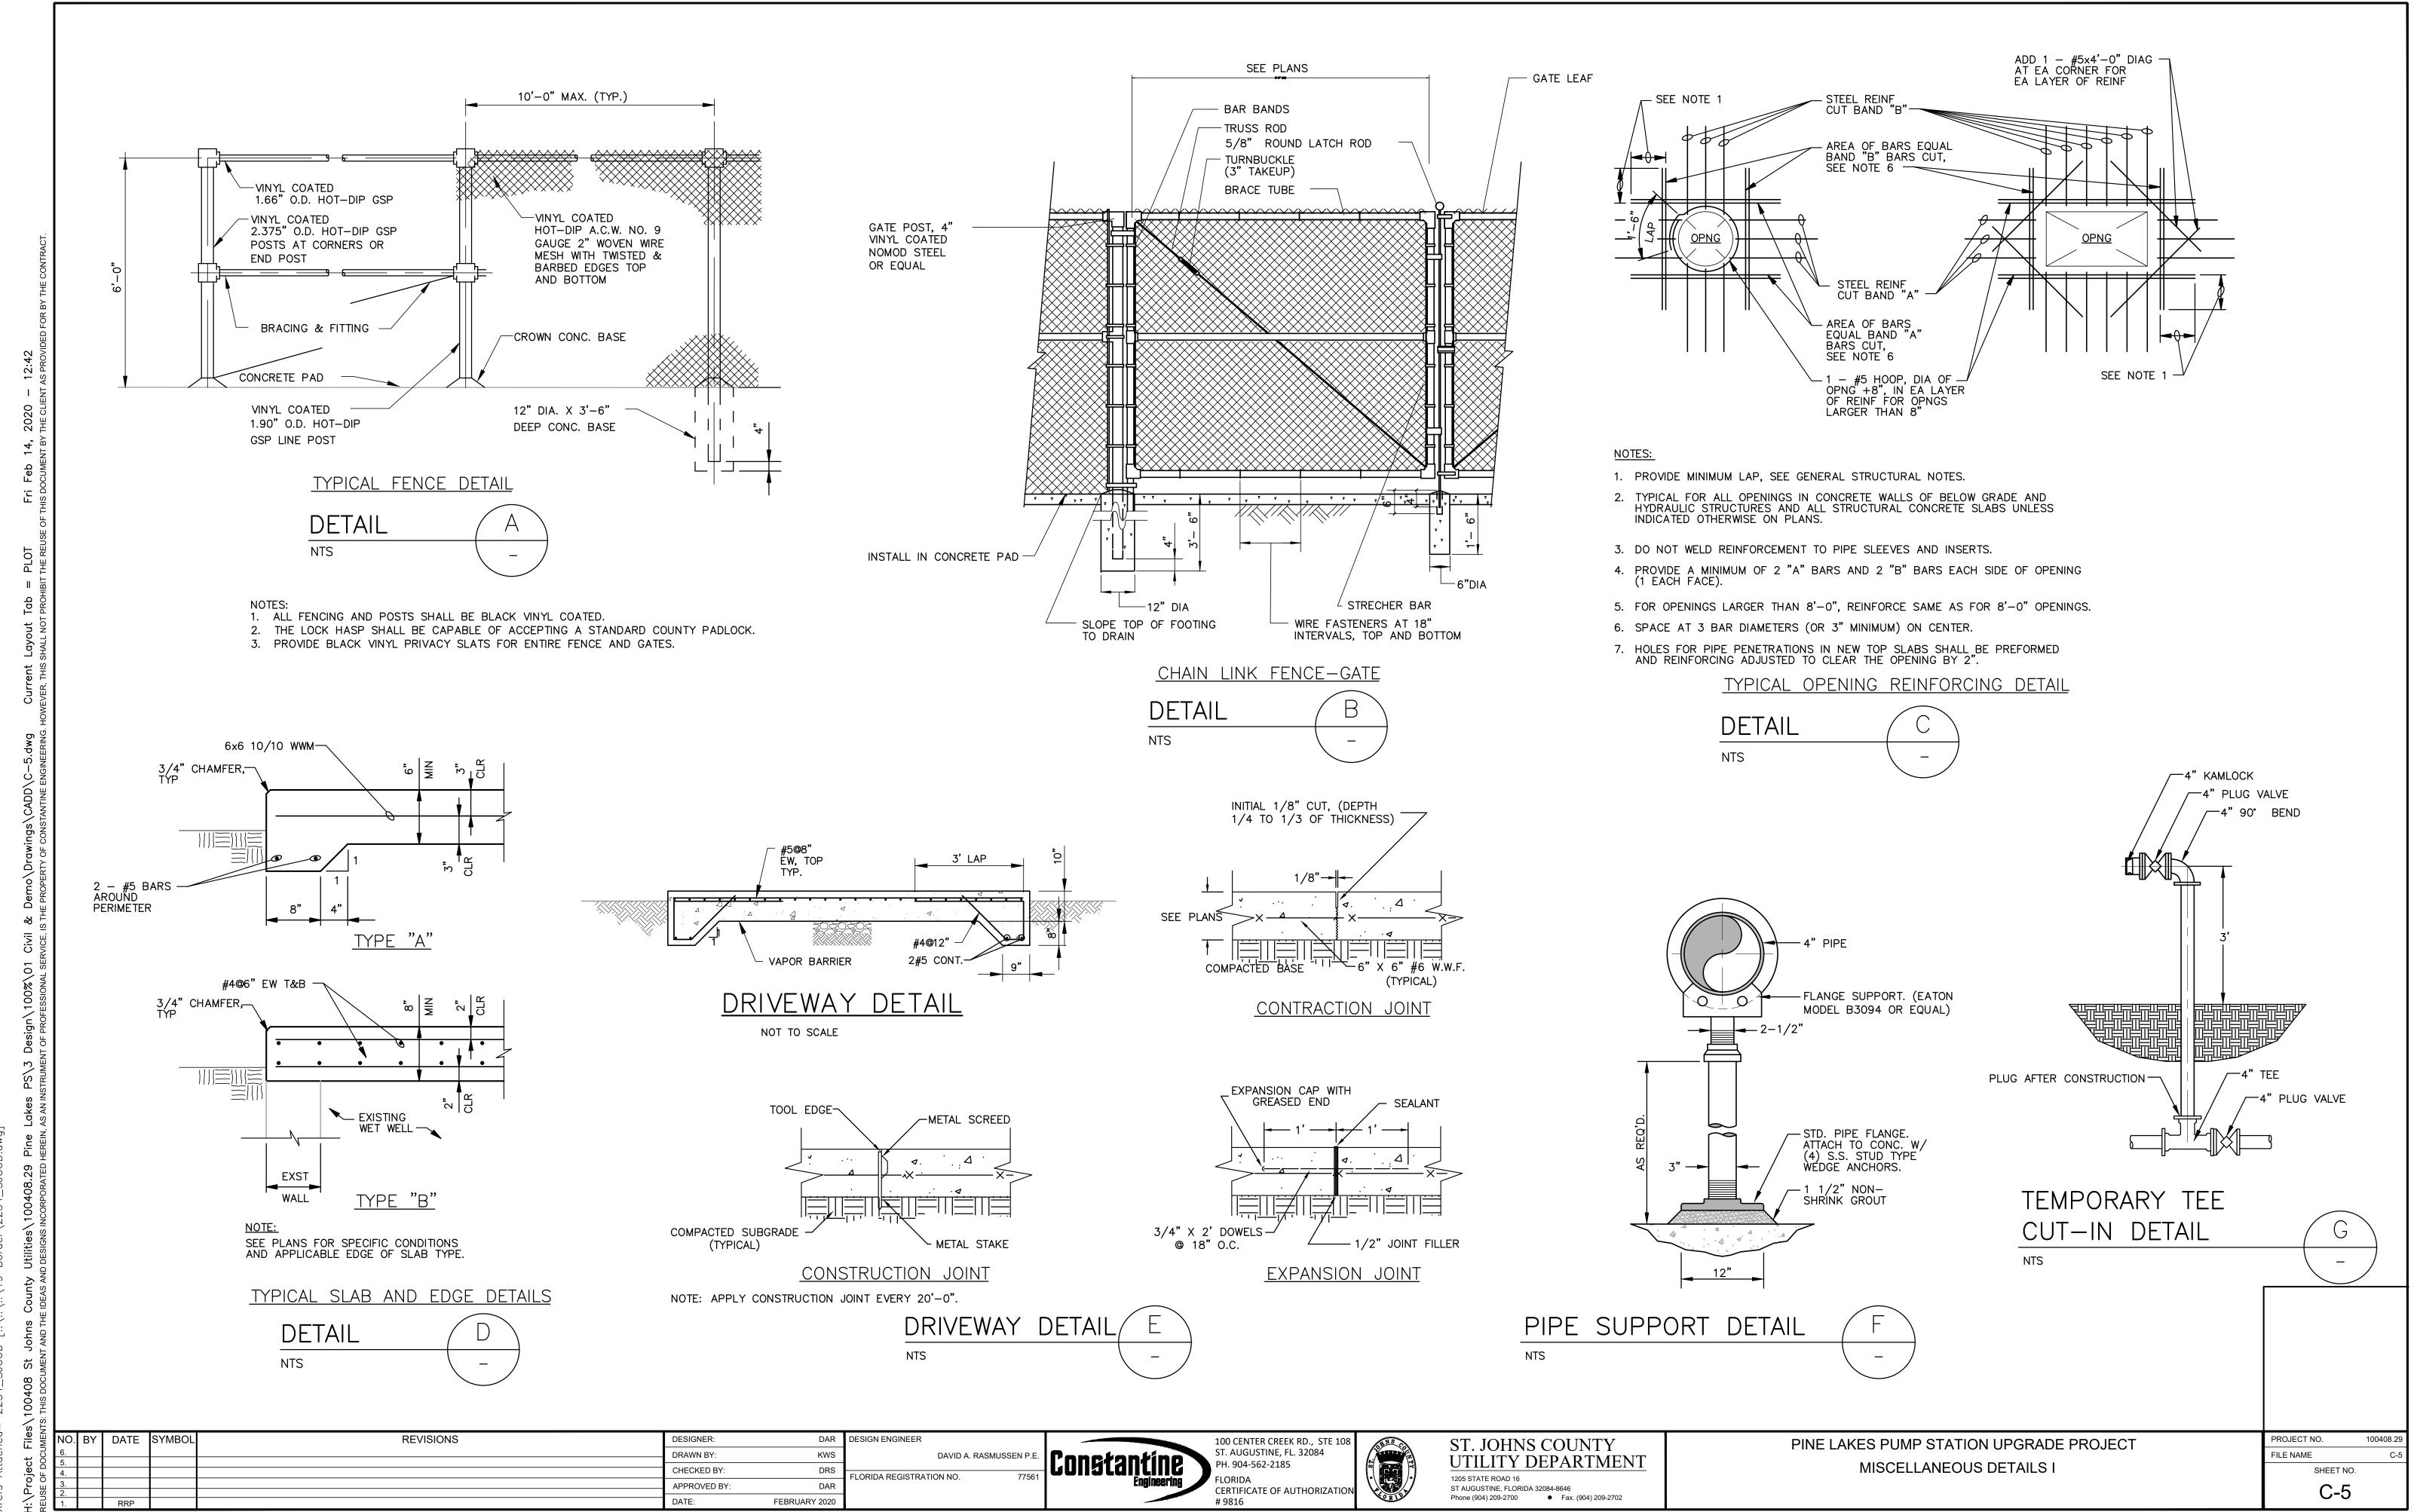

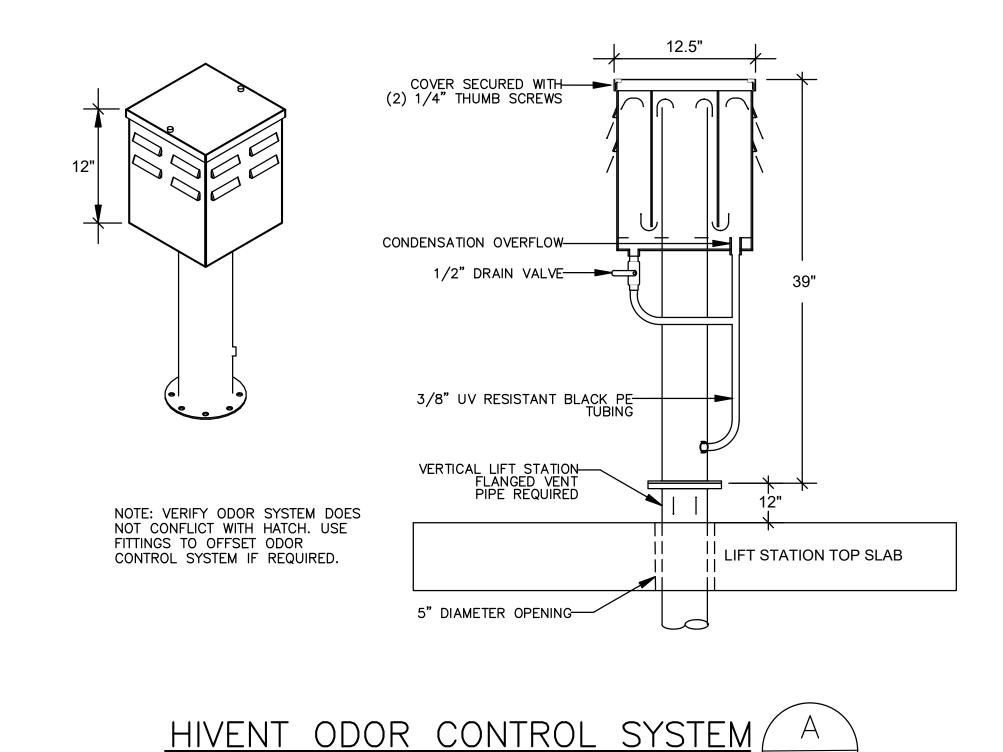

NO SCALE

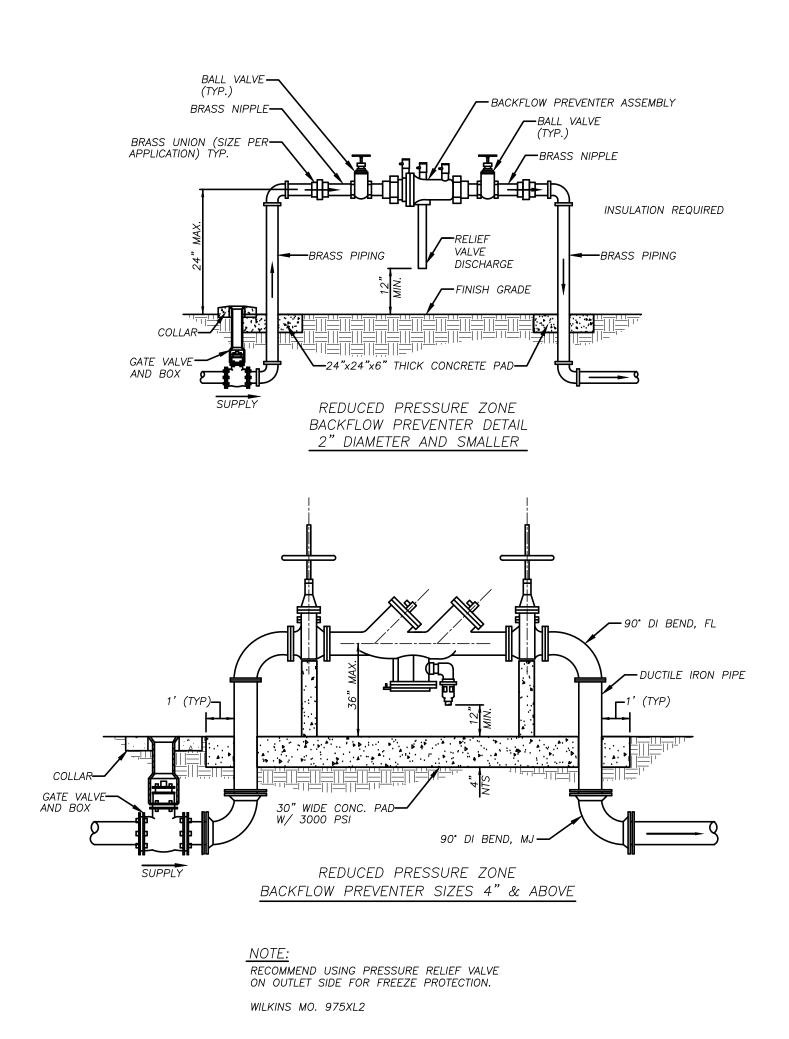

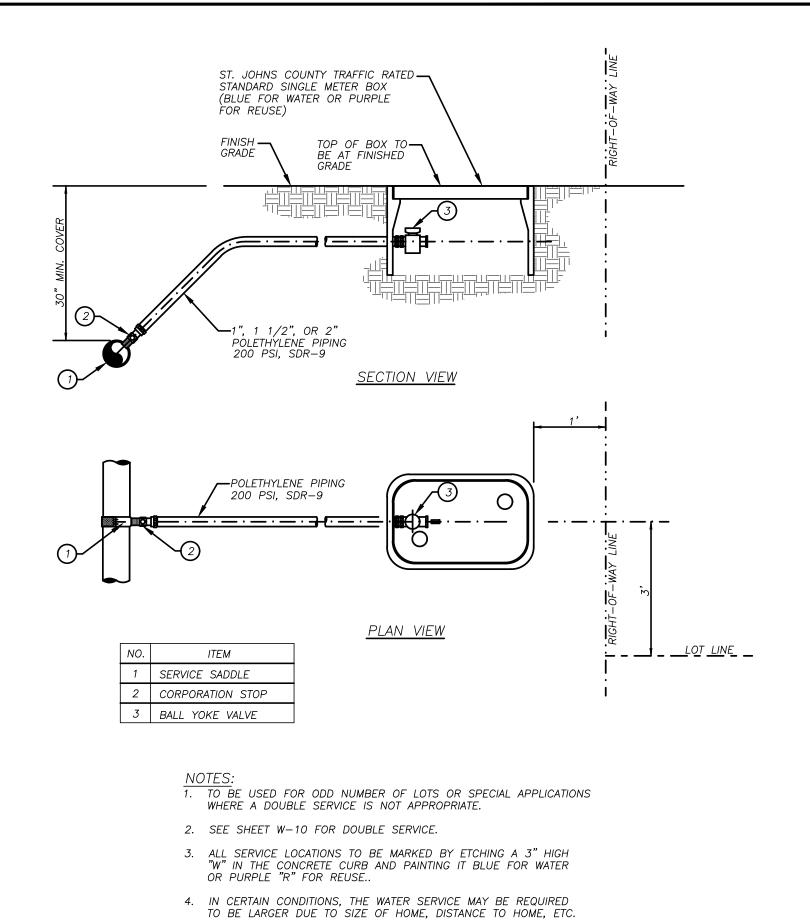






6. FOR PHASED NON-RESIDENTIAL DEVELOPMENT, A MINIMUM 2" TAP MAY BE REQUIRED TO ACCOMODATE FUTURE EXPANSION.

7. ALL BRASS FITTINGS IN CONTACT WITH POTABLE WATER SHALL MEET NSF 61 REQUIREMENTS FOR NO LEAD.


5. DO NOT INSTALL IN DRIVEWAYS OR SIDEWALKS.

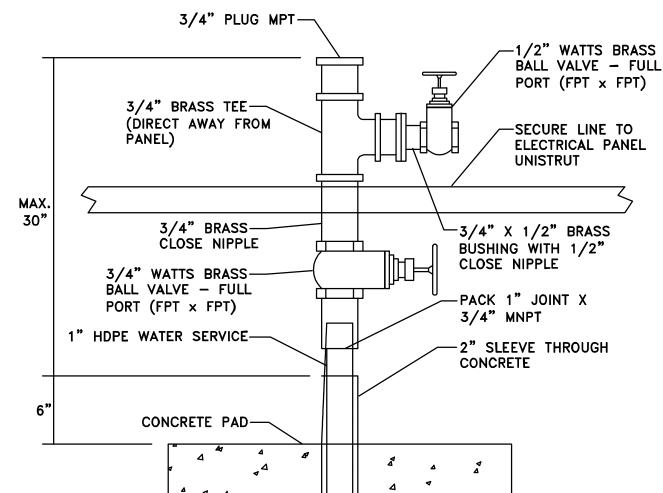

STATIC WATER LINE END CONNECTION

REVISIONS

NO. BY DATE SYMBOL

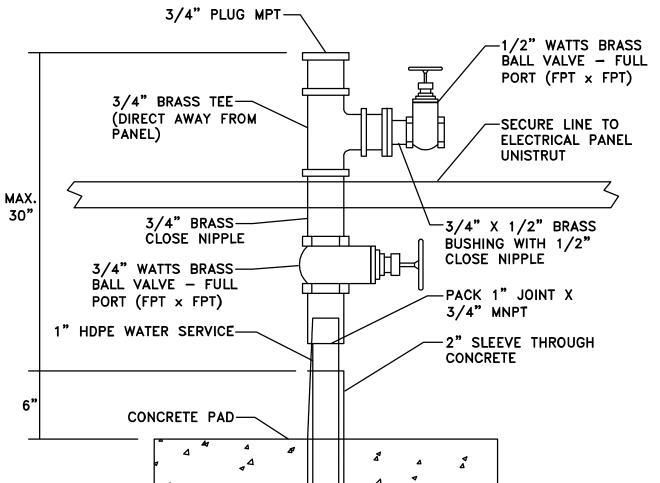

DAVID A. RASMUSSEN P.E **Constantine**

DESIGN ENGINEER

LORIDA REGISTRATION NO.

KWS

DAR

FEBRUARY 2020

DESIGNER:


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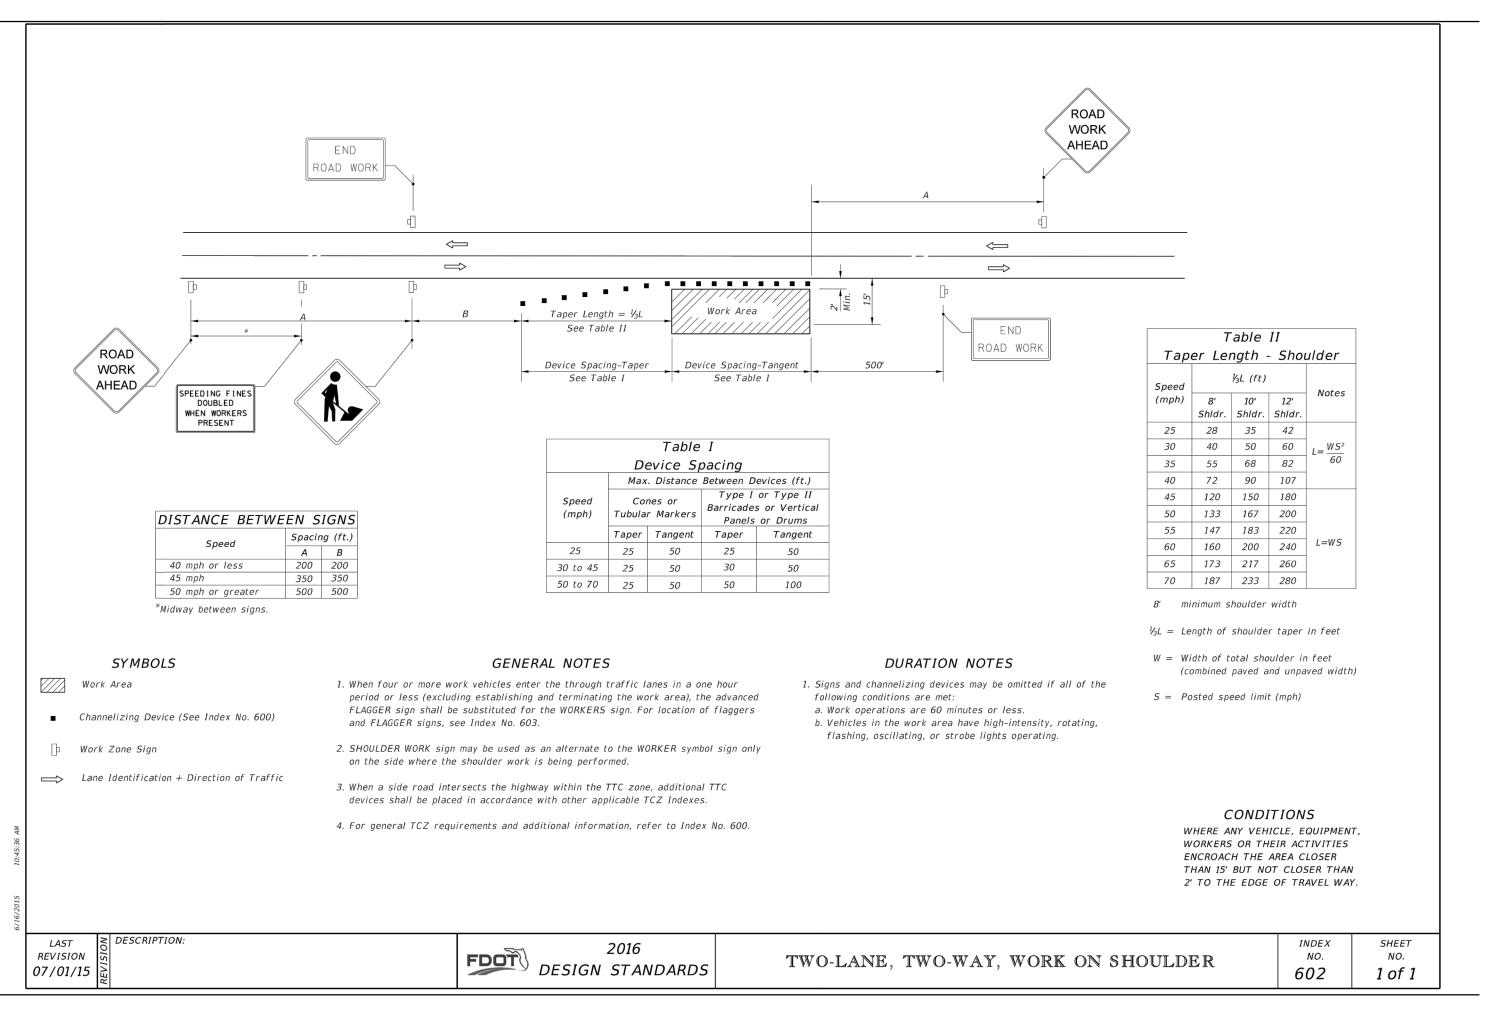
APPROVED BY:

100 CENTER CREEK RD., STE 108 ST. AUGUSTINE, FL. 32084 CERTIFICATE OF AUTHORIZATION

ST. JOHNS COUNTY UTILITY DEPARTMENT 1205 STATE ROAD 16 ST AUGUSTINE, FLORIDA 32084-8646 Phone (904) 209-2700 • Fax. (904) 209-2702

PINE LAKES PUMP STATION UPGRADE PROJECT MISCELLANEOUS DETAILS II AND COUNTY DETAILS PROJECT NO. 100408.29 FILE NAME SHEET NO. C-6



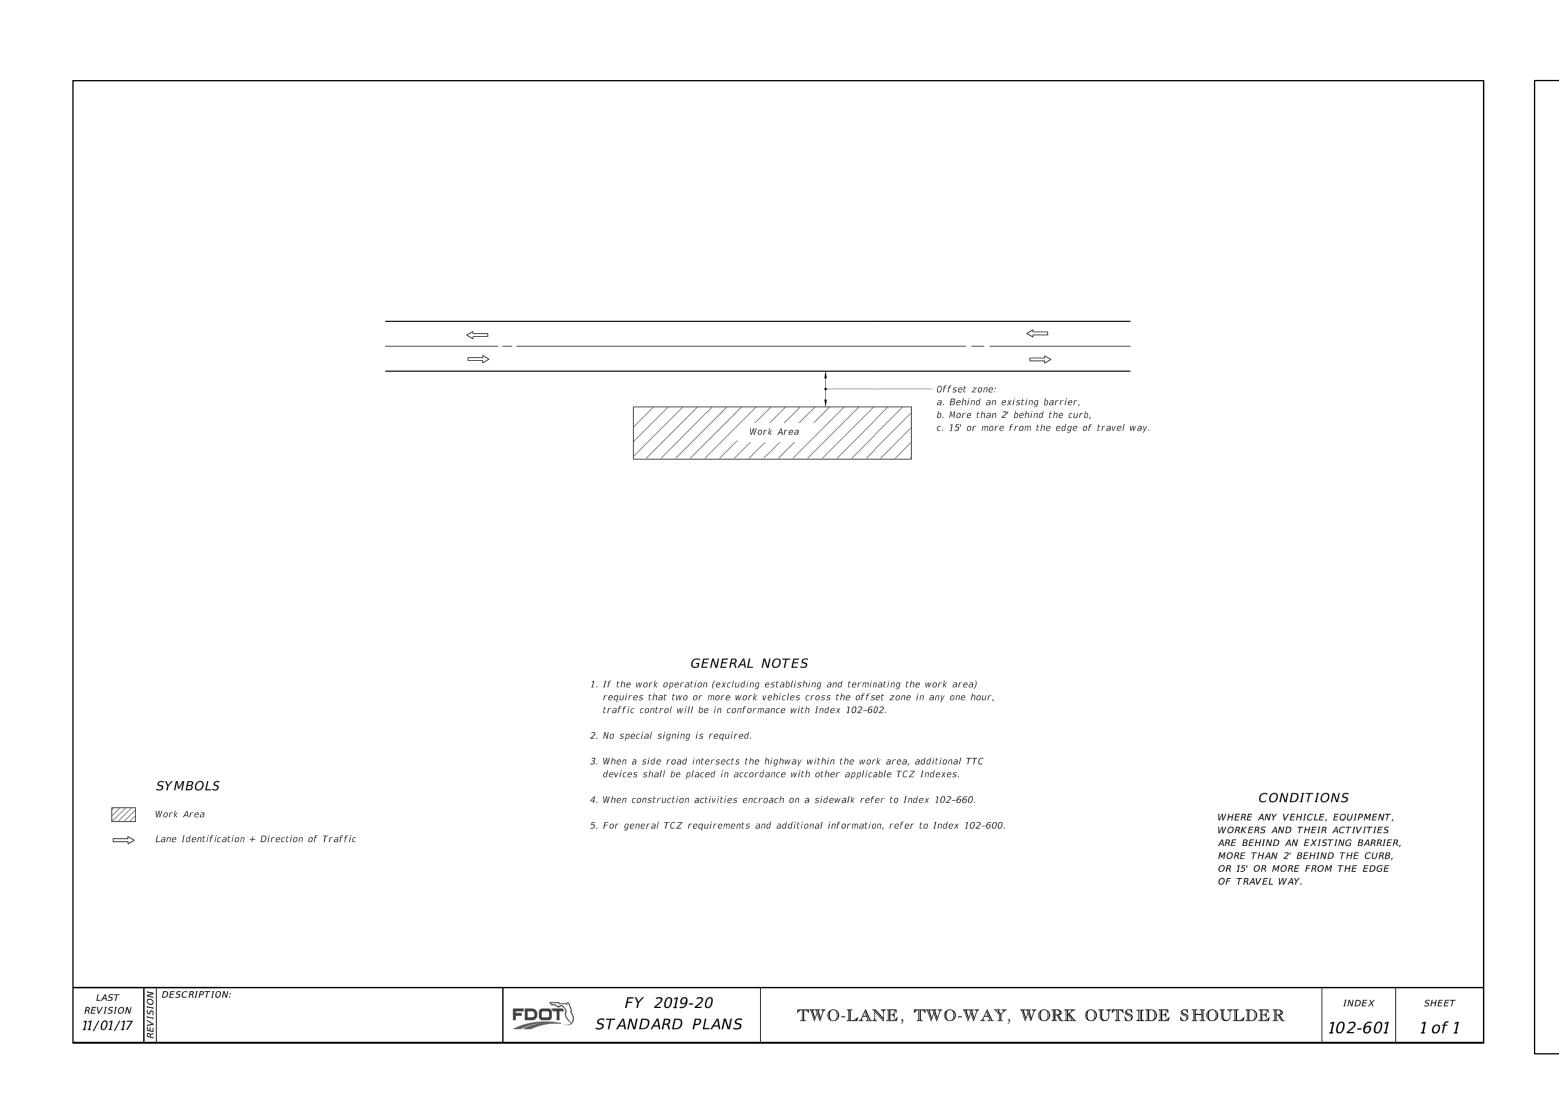

SJCUD NOTES:

- 1. THE CONTRACTOR SHALL CARRY ON THE WORK IN A MANNER. WHICH WILL CAUSE A MINIMUM OF INTERRUPTION TO TRAFFIC, WHERE TRAFFIC MUST CROSS OPEN TRENCHES, THE CONTRACTOR SHALL PROVIDE SUITABLE BRIDGES AT STREET INTERSECTIONS AND DRIVEWAYS. THE CONTRACTION SHALL POST SUITABLE SIGNS INDICATING THAT A STREET IS CLOSED AND NECESSARY DETOUR SIGNS FOR THE PROPER MAINTENANCE OF TRAFFIC. PRIOR TO CLOSING OF ANY STREETS, THE CONTRACTOR SHALL NOTIFY AND OBTAIN THE APPROVAL OF RESPONSIBLE AUTHORITIES AND THE COUNTY.
- 2. UNLESS PERMISSION TO CLOSE A STREET IS RECEIVED IN WRITING FROM THE PROPER AUTHORITY (COUNTY, CITY, FDOT, ETC.), ALL EXCAVATED MATERIAL SHALL BE PLACED SO THAT VEHICULAR AND PEDESTRAIN TRAFFIC MAY BE MAINTAINED AT ALL TIMES.IF THE CONTRACTOR'S OPERATIONS CAUSE TRAFFIC HAZARDS. HE SHALL REPAIR THE ROAD SURFACE, PROVIDE TEMPORARY WAYS, ERECT WHEEL GUARDS OR FENCES, OR TAKE OTHER MEASURES FOR SAFETY SATISFACTORY TO THE COUNTY.
- 3. DETOURS AROUND CONSTRUCTION WILL BE SUBJECTED TO THE APPROVAL OF THE AUTHORITY HAVING JURISDICTION AND THE COUNTY. WHERE DETOURS ARE PERMITTED, THE CONTRACTOR SHALL PROVIDE ALL NECESSARY BARRICADES AND SIGNS ARE REQUIRED TO DIVERT THE FLOW OF TRAFFIC. WHILE TRAFFIC IS DETOURED THE CONTRACTOR SHALL EXPEDITE CONSTRUCTION OPERATIONS. PERIODS WHEN TRAFFIC IS BEING DETOUR WILL BE STRICTLY CONTROLLED BY THE COUNTY.
- 4. IT SHALL BE THE SOLE RESPONSIBILITY OF THE CONTRACTOR TO TAKE PRECAUTIONS TO PREVENT INJURY TO THE PUBLIC DUE TO OPEN TRENCHES. NIGHT WATCHMEN MAY BE REQUIRED WHERE SPECIAL HAZARDS EXIST, OR POLICE PROTECTION PROVIDED FOR TRAFFIC WHILE WORK IS IN PROGRESS. THE CONTRACTOR SHALL BE FULLY RESPONSIBLE FOR DAMAGE OR INJURIES WHETHER OR NOT POLICE PROTECTION HAS BEEN PROVIDED.
- 5. CONTRACTOR SHALL COORDINATE WITH SJCUD RIGHT-OF-WAY INSPECTOR BEFORE PERFORMING WORK IN THE RIGHT-OF-WAY.

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DESIGN ENGINEER DAVID A. RASMUSSEN P.E FLORIDA REGISTRATION NO.







PINE LAKES PUMP STATION UPGRADE PROJECT MAINTENANCE OF TRAFFIC DETAILS I

PROJECT NO. 100408.29 FILE NAME SHEET NO.

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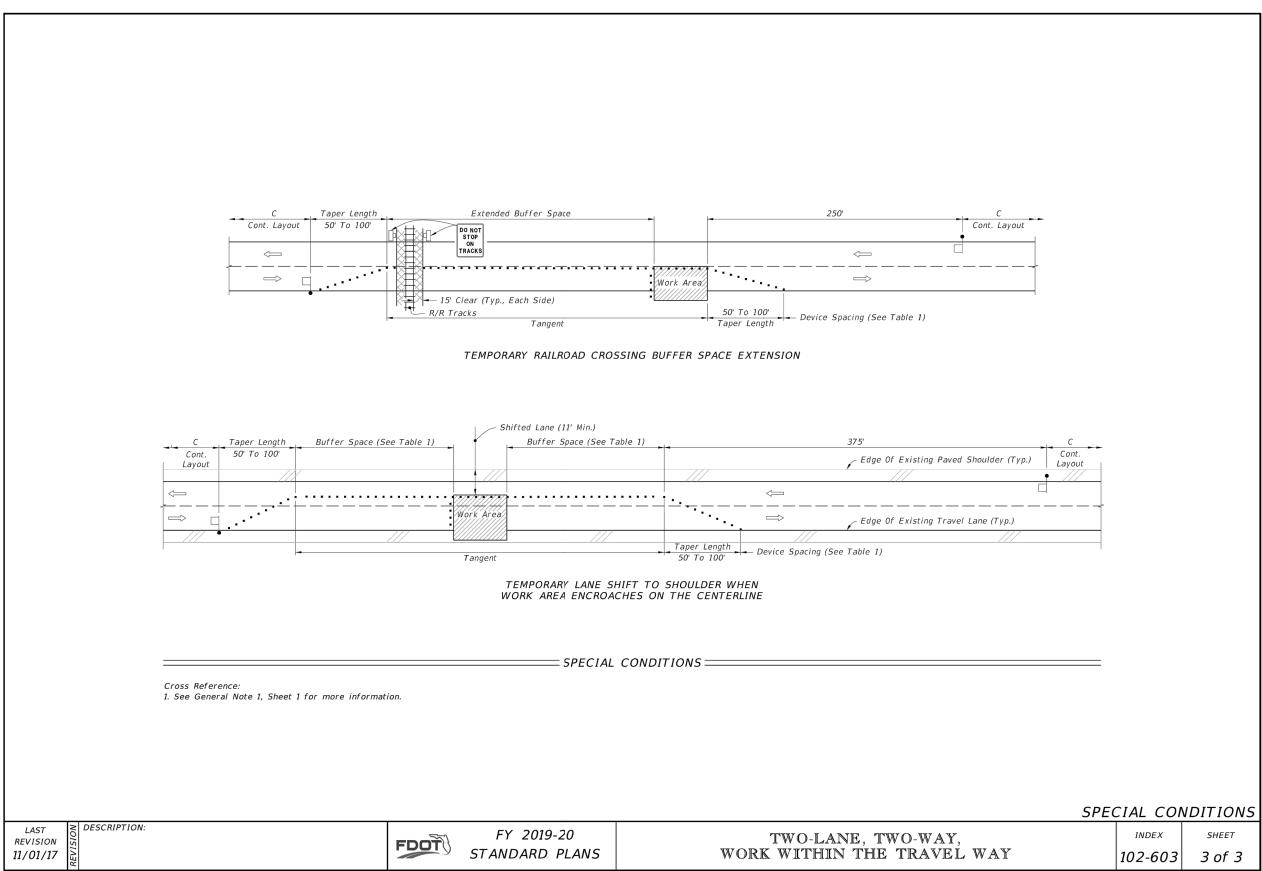


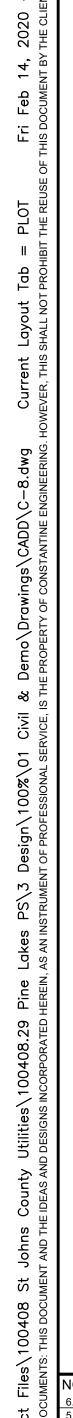


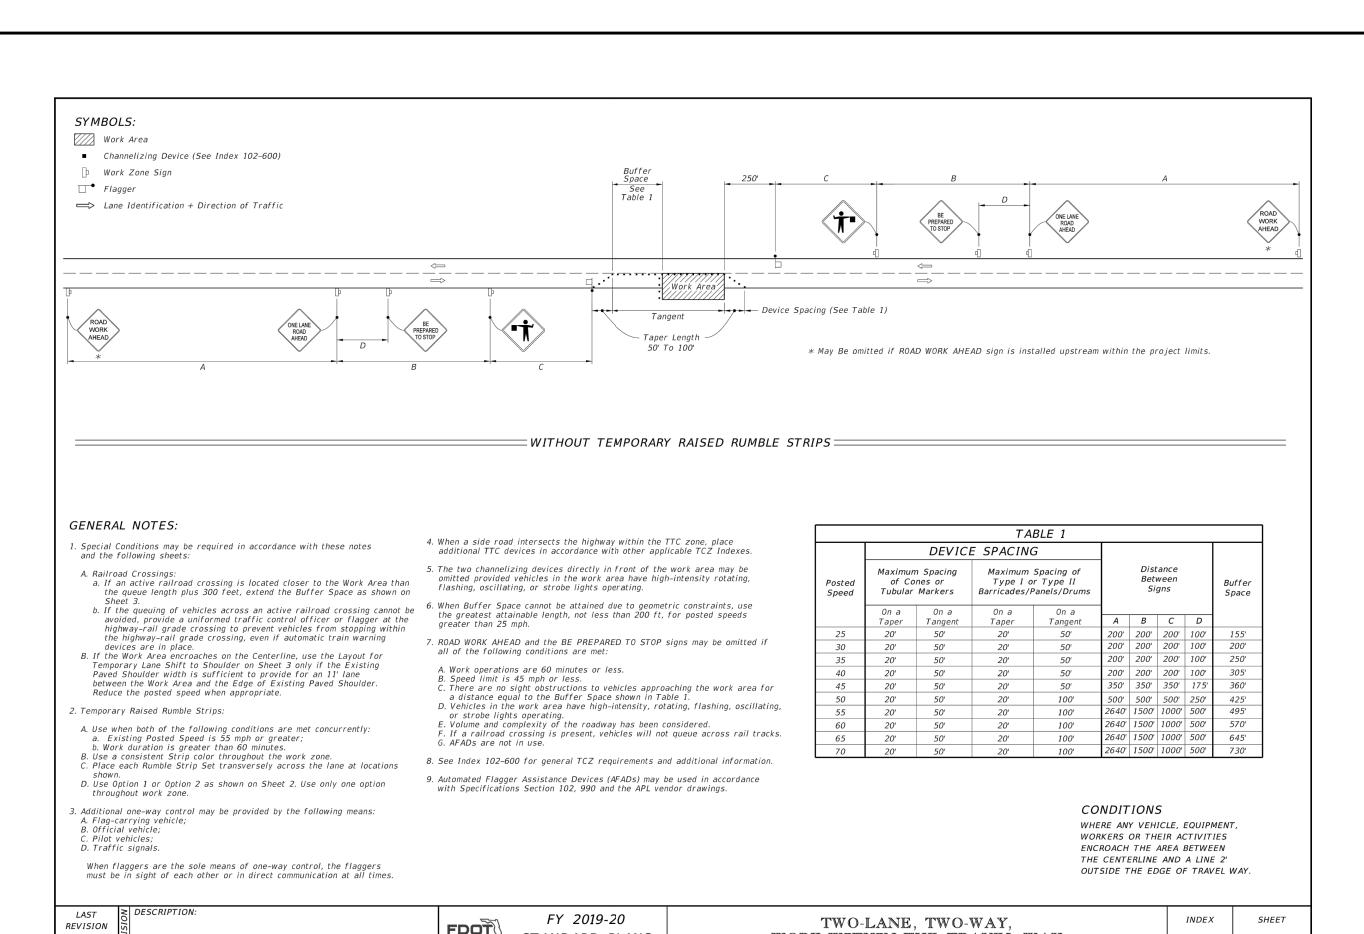
WORK WITHIN THE TRAVEL WAY

102-603 1 of 3

STANDARD PLANS



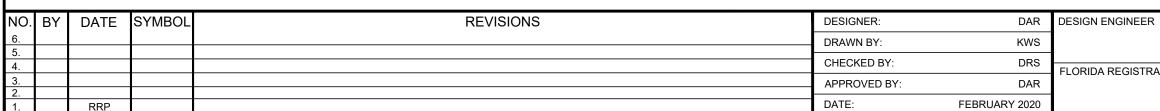

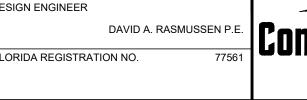





PINE LAKES PUMP STATION UPGRADE PROJECT MAINTENANCE OF TRAFFIC DETAILS II


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NOTES:

- DESIGN DRAWINGS ARE DIAGRAMMATIC AND INTENDED TO SHOW THE GENERAL REQUIREMENTS. ALL EQUIPMENT AND INSTALLATION SHALL BE IN ACCORDANCE WITH ST. JOHNS COUNTY DESIGN STANDARDS AND SPECIFICATIONS.
- 2. ALL MATERIAL SHALL BE NEW AND SHALL CONFORM WITH THE STANDARDS OF THE UNDERWRITERS' LABORATORIES, INC., AMERICAN NATIONAL STANDARDS INSTITUTE, NATIONAL ELECTRICAL MANUFACTURERS' ASSOCIATION, INSULATED POWER CABLE ENGINEERS ASSOCIATION, AND INSTITUTE OF ELECTRICAL AND ELECTRONIC ENGINEERS, IN EVERY CASE WHERE SUCH A STANDARD HAS BEEN ESTABLISHED FOR THE PARTICULAR TYPE OF MATERIALS IN QUESTION.
- THE INSTALLATIONS SHALL BE IN ACCORDANCE WITH THE REGULATIONS OF THE LATEST EDITIONS OF THE NATIONAL ELECTRICAL CODE, NATIONAL ELECTRICAL SAFETY CODE, APPLICABLE CITY, STATE, AND LOCAL CODES AND REGULATIONS AND OTHER APPLICABLE CODES, INCLUDING UTILITY COMPANY CODES.
- ALL PERMITS REQUIRED BY STATE OR LOCAL ORDINANCES SHALL BE OBTAINED, AND AFTER COMPLETION OF THE WORK, A CERTIFICATE OF FINAL INSPECTION AND APPROVAL FROM THE ELECTRICAL INSPECTOR SHALL BE FURNISHED TO THE OWNER. ALL PERMITS FOR INSTALLATION, INSPECTIONS, CONNECTIONS, ETC., SHALL BE TAKEN OUT AND PAID FOR BY THE CONTRACTOR AS PART OF THE WORK UNDER THIS SECTION.
- ALL MATERIALS AND WORKMANSHIP SHALL BE GUARANTEED TO BE FREE FROM DEFECTS. ANY PART OF THE SYSTEM CONSIDERED DEFECTIVE BY THE ENGINEER WITHIN THE GUARANTEE PERIOD SHALL BE IMMEDIATELY REPLACED OR CORRECTED TO THE ENGINEER'S SATISFACTION WITHOUT FURTHER EXPENSE TO
- THE PROJECTS GROUNDING SYSTEM SHALL CONSIST OF A GROUNDING ELECTRODE SYSTEM IN ACCORDANCE WITH NEC SPECIFICATIONS, BONDED TO A MAIN GROUND BUS INTERCONNECTING ALL POWER DISTRIBUTION EQUIPMENT. GROUND ROD SECTIONS SHALL BE COUPLED AND DRIVEN TO ESTABLISH A MAXIMUM RESISTANCE TO GROUND OF 5 OHMS THROUGHOUT THE GROUNDING SYSTEM.
- UNLESS OTHERWISE INDICATED, ELECTRICAL EQUIPMENT ENCLOSURES SHALL BE NEMA 12/3R ALUMINUM OR 316 STAINLESS STEEL; CONDUCTORS SHALL BE STRANDED AWG TYPE XHHW-2 COPPER; CONDUCTORS WITHIN THE WET WELL TERMINAL BOXES SHALL BE TYPE XHHW-2 TINNED COPPER. UNDERGROUND CONDUIT SHALL BE SCH 40 PVC; EXPOSED CONDUIT SHALL BE SCH 80 PVC; CONDUIT INTO THE WET WELL SHALL BE PVC COATED RIGID ALUMINUM; SUPPORT CHANNEL AND MOUNTING STRUT SHALL BE MINIMUM 1.5" x 1.5" ALUMINUM. ALL MOUNTING HARDWARE SHALL BE 316 STAINLESS STEEL, INCLUDING BUT NOT LIMITED TO NUTS, BOLTS, WASHERS, BRACKETS, ETC. NUTS AND BOLTS WITH ANTI-SEIZE COMPOUND SHALL BE USED. SCREWS ARE NOT ALLOWED. ALL MATERIALS AND INSTALLATION SHALL BE SUITABLE FOR "CORROSIVE ATMOSPHERES".
- THE PUMP CONTROL PANEL WET WELL LEVEL CONTROL SYSTEM SHALL INCLUDE LEAD PUMP SELECTOR SWITCH AND AUTOMATIC ALTERNATOR FOR AUTOMAITIC LEAD/LAG PUMP CONTROL AND ALTERNATION; AND 24V CONTROL POWER TRANSFORMER AND HIGH/LAG/LEAD/OFF LEVEL FLOAT SWITCHES FOR PUMP CONTROL AND HIGH LEVEL ALARM.
- DUCT SEAL IS REQUIRED AT ALL CONDUIT CONNECTIONS IN AND OUT OF THE EQUIPMENT CABLE TERMINAL BOXES. ADDITIONALLY, DUCT SEAL IS REQUIRED AT ALL CONDUIT CONNECTIONS IN AND OUT OF THE PUMP CONTROL PANEL.
- PROVIDE SITE LIGHT POLE WITH SERVICE FROM THE PUMP CONTROL PANEL (3/4"C, 3#12). PROVIDE WP DUPLEX GFI RECEPTACLE WITH CAST ALUMINUM BOX AND COVER, AND WP LIGHT SWITCH WITH CAST ALUMINUM BOX AND COVER, MOUNTED ADJACENT TO THE PUMP CONTROL PANEL. SITE LIGHT POLE SHALL BE FIBERGLASS DIRECT BURIED POLE WITH BLACK FINISH. LUMINAIRE SHALL BE AEL MODEL LNH2-LU5-MVOLT-R5-BA-SH WITH 18" LONG ALUMINUM SPOKE BRACKET ARM. LUMINAIRE MOUNTING HEIGHT SHALL BE 12'. LOCATE LIGHT POLE ON RIGHT-HAND SIDE OF THE PUMP CONTROL PANEL.
- IN ACCORDANCE WITH THE LATEST ST. JOHNS COUNTY UTILITIES DEPARTMENT STANDARDS, THE NEW PUMP CONTROL PANEL, EXPLOSION PROTECTED TYPE EX TERMINAL BOXES, WET WELL LEVEL CONTROLS, AND UL SERVICE ENTRANCE MAIN FUSED DISCONNECT SWITCH SHALL BE FURNISHED BY THE SJCUD APPROVED LIFT STATION ELECTRICAL EQUIPMENT SUPPLIER.
- 12. IN ACCORDANCE WITH THE LATEST ST. JOHNS COUNTY UTILITIES DEPARTMENT STANDARDS, THE SCADA SYSTEM RTU, ANTENNA MAST, AND ANTENNA, SHALL BE PROVIDED BY A SJCUD APPROVED SCADA SYSTEM INTEGRATOR. FOR STATIONS EQUIPPED WITH FORCE MAIN PRESSURE SENSORS AND/OR WATER MAIN PRESSURE SENSORS, THE PRESSURE SENSORS SHALL BE PROVIDED BY THE SCADA SYSTEM INTEGRATOR.

ELECTRICAL SYSTEMS ANALYSIS:

- SJCUD SHALL OBTAIN THE SERVICES OF AN INDEPENDENT SPECIALTY ENGINEERING FIRM TO PROVIDE A PRELIMINARY AND A FINAL SHORT CIRCUIT, DEVICE EVALUATION, PROTECTIVE DEVICE COORDINATION, AND ARC FLASH STUDY OF THE COMPLETE ELECTRICAL DISTRIBUTION SYSTEM, IN ACCORDANCE WITH SJCUD STANDARDS
- THE CONTRACTOR SHALL PROVIDE, WITH THE SHOP DRAWING SUBMITTALS, A LISTING OF THE FOLLOWING INFORMATION FOR EACH POWER DISTRIBUTION FEEDER: CONDUIT SIZE, CONDUIT TYPE, CONDUCTOR SIZE, CONDUCTOR TYPE, CONDUCTOR LENGTH.
- THE SERVICE ENTRANCE MAIN FUSED DISCONNECT SWITCH FUSE SELECTION SHALL BE IN ACCORDANCE WITH THE SJCUD STANDARDIZED FUSES: FERRAZ SHAWMUT TRS100R AND TRS200R. HOWEVER, SELECTION OF AN INTERMEDIATE TRS-R FUSE SHALL BE UTILIZED WHEN POSSIBLE TO REDUCE THE DOWNSTREAM HAZARD RISK CATEGORY.
- THE CONTRACTOR SHALL PROVIDE THE SERVICE ENTRANCE FUSE SIZE DETERMINED BY THE FINAL APPROVED ELECTRICAL SYSTEMS ANALYSIS.

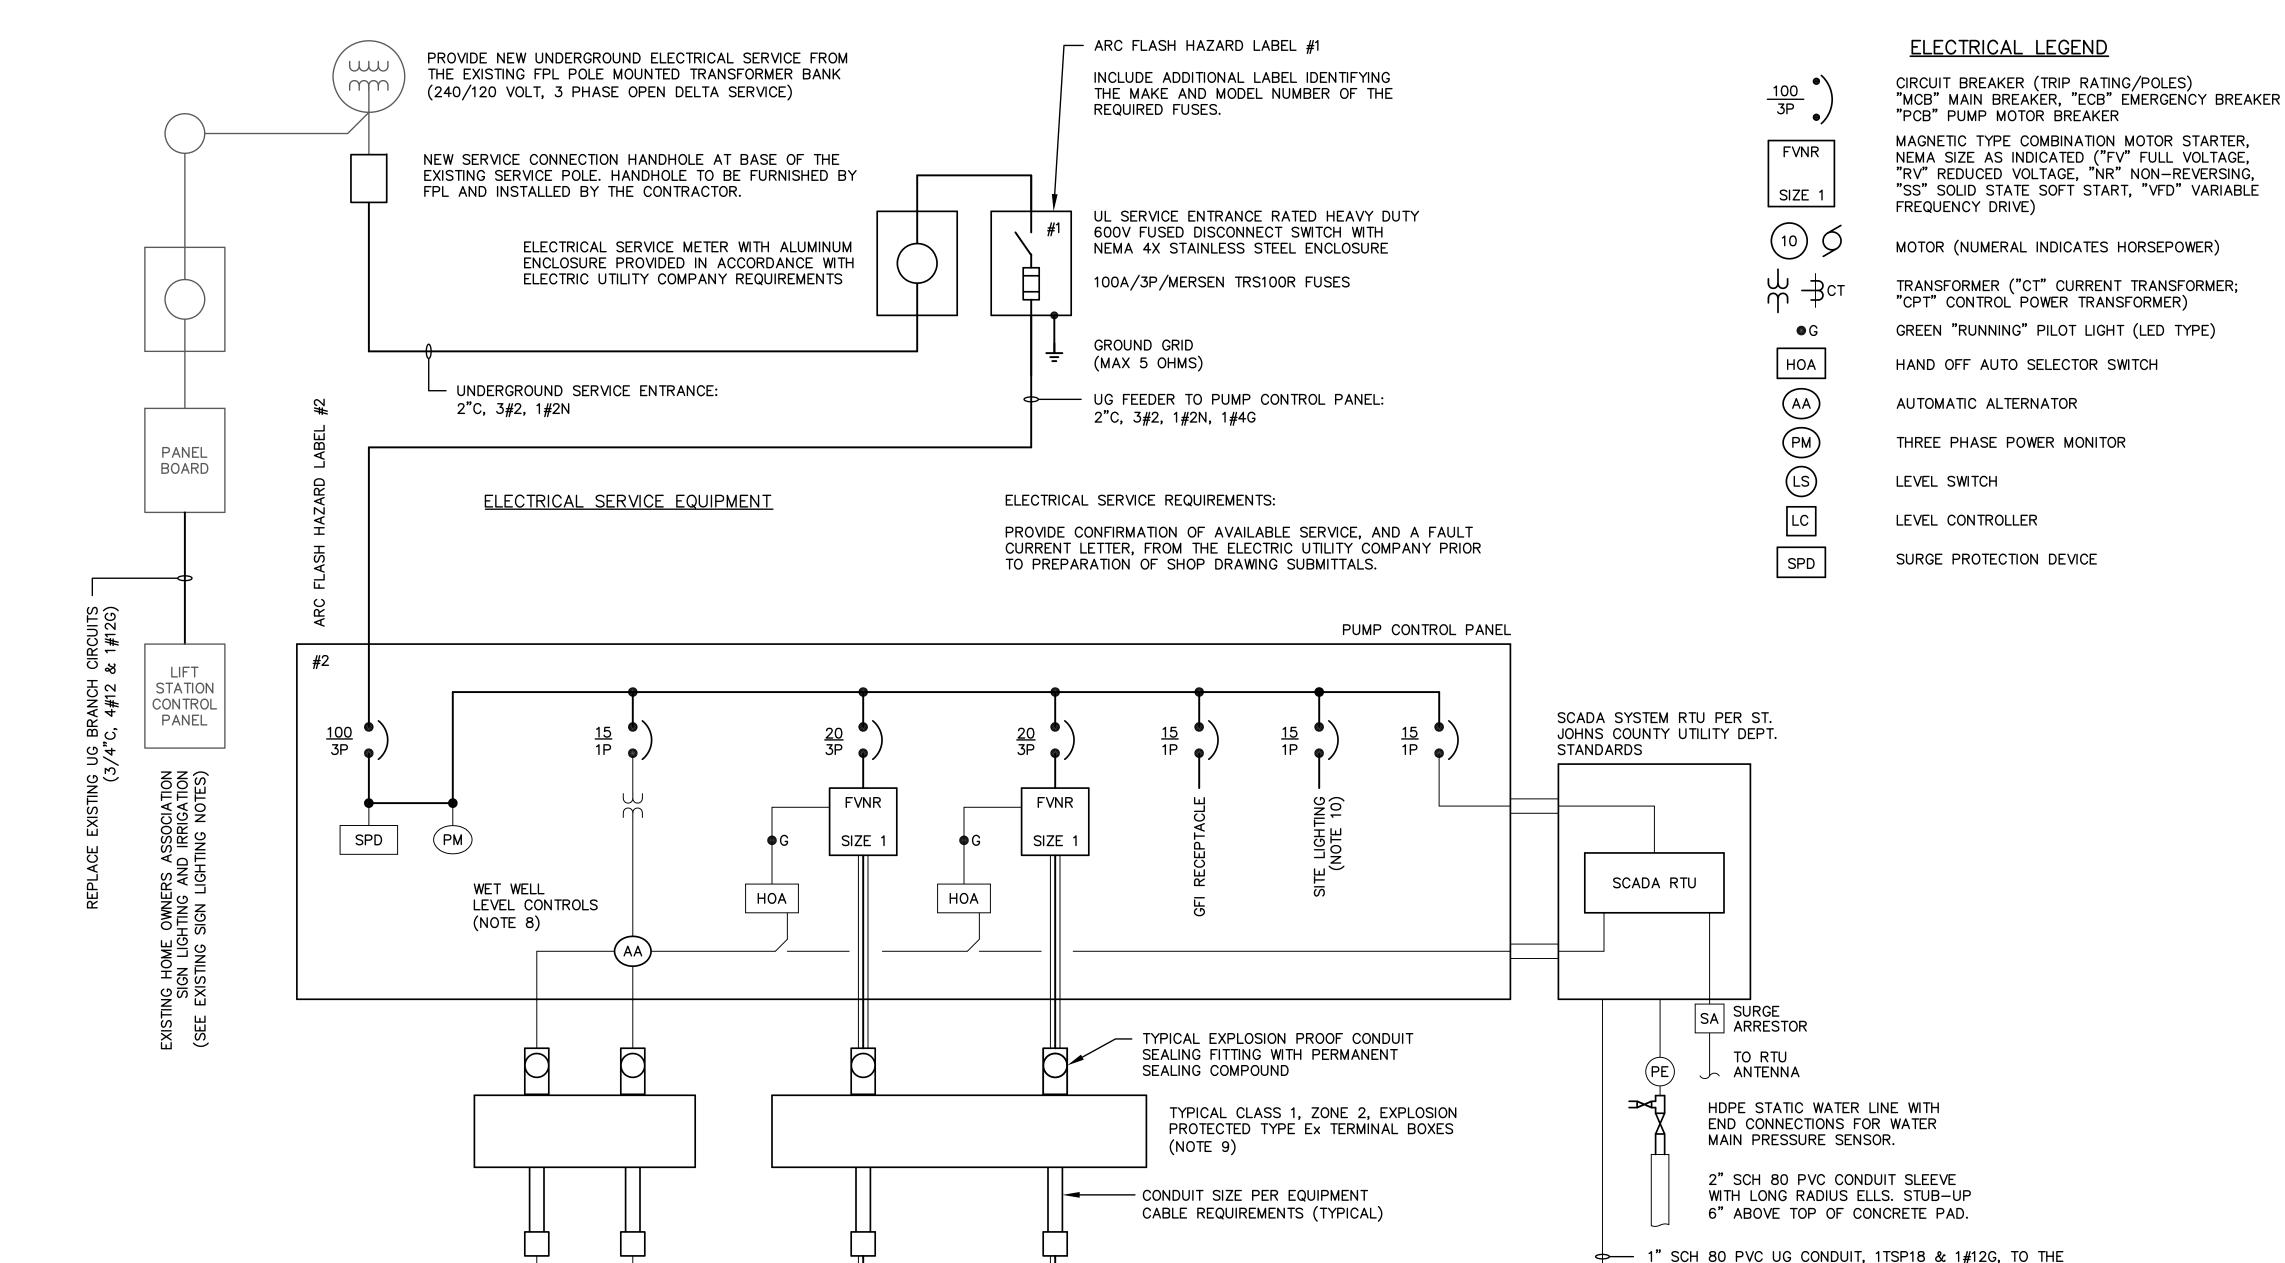

ALL ALL EQUIPMENT LOCATED WITHIN THE WET WELL AND EXPOSED TO POTENTIAL HAZARDOUS CONCENTRATIONS OF FLAMMABLE GASES OR VAPORS, SHALL BE RATED FOR CLASS I, DIVISION 1, GROUP D LOCATIONS. ALL ELECTRICAL EQUIPMENT AND INSTALLATION SHALL BE SUITABLE FOR CORROSIVE CONDITIONS.

PUMP

OFF

LEAD

START

FLOAT SWITCHES

LAG

START

HIGH

ALARM

PINE LAKES LIFT STATION - SINGLE LINE DIAGRAM

PUMPING STATION PUMPS

FPL ALLOWANCE:

1. THE CONTRACTOR SHALL INCLUDE A BID ALLOWANCE IN THE AMOUNT OF \$2,500 AS A CONTRIBUTION IN AID OF CONSTRUCTION PAYMENT TO FPL TO PROVIDE THE MODIFICATIONS TO THE EXISTING ELECTRICAL SERVICE.

LORIDA REGISTRATION NO.

MAINTAIN THE EXISTING SIGN LIGHTING SERVICE POLE. RELOCATE SERVICE MAST, SERVICE METER AND PANELBOARD TO THE NORTH SIDE OF THE POLE.

TYPICAL SUBMERSIBLE WASTEWATER PUMP

MOTOR. WET WELL LEVEL CONTROLS SHALL

BE ADJUSTED TO MAINTAIN SUBMERGENCE

FOR ISOLATION FROM THE ATMOSPHERE

ELECTRICAL LOAD CALCULATIONS

LLLOTRICAL	LOAD CALC	OLA HONE	,	
LIFT STATION PUMP LIFT STATION PUMP				AMPS
TOTAL MOTOR LOAD LIGHTING AND CONTR	ROLS 3			AMPS
TOTAL CONNECTED L				AMPS AMPS
PEAK DEMAND AMPS 0.25 X LARGEST MO			. •	AMPS AMPS
MIN SERVICE AMPACI MIN MAIN BREAKER		_		AMPS

ELECTRICAL SERVICE: 100 AMP, 240/120 VOLT, 3 PHASE

EXISTING SIGN LIGHTING NOTES:

No.2

REPLACE THE EXISTING UG BRANCH CIRCUITS FROM THE PANELBOARD TO THE SIGN (3/4" SCH 40 PVC, 4#12 & 1#12G).

NO. BY DATE SYMBOL **DESIGN ENGINEER REVISIONS** DESIGNER: WDL TCG DRAWN BY CHECKED BY WDL APPROVED BY: TCG



100 CENTER CREEK RD., STE 10 ST. AUGUSTINE, FL. 32084 H. 904-562-2185 CERTIFICATE OF AUTHORIZATION



PINE LAKES PUMP STATION UPGRADE PROJECT

FORCE MAIN PRESSURE TRANSMITTER. STUB-UP 2' ABOVE

TOP OF CONCRETE PAD. LOCATE BELOW PUMP DISCHARGE

FORCE MAIN PRESSURE TRANSMITTER FURNISHED

PIPING TO AVOID TRIP HAZARD.


SCADA SYSTEM EQUIPMENT

BY THE SCADA SYSTEM CONTRACTOR

PROJECT NO. FILE NAME 852E00P4.DW SHEET NO. ELECTRICAL SINGLE LINE DIAGRAM

100408.29


- 2. THE CONTRACTOR SHALL SCHEDULE AN ELECTRICAL ROUGH—IN SITE INSPECTION WITH SJCUD AND THE ELECTRICAL DESIGN ENGINEER TO INSPECT THE ELECTRICAL EQUIPMENT INSTALLATION PRIOR TO POURING CONCRETE.
- 3. GROUNDING ELECTRODE SYSTEM: PROVIDE A GROUND RING PER NEC 250.52, ENCIRCLING THE ELECTRICAL SERVICE EQUIPMENT, CONSISTING OF CONTINUOUS #1/O TINNED COPPER CONDUCTOR AT 30" BELOW GRADE.
- 4. PROVIDE GROUND RODS (MINIMUM 3/4" DIAMETER, 20' LONG COPPER CLAD STEEL) BONDED TO EACH END OF THE GROUND RING, AT LEAST 20' APART. GROUND ROD SECTIONS SHALL BE COUPLED AND DRIVEN TO ESTABLISH A MAXIMUM RESISTANCE TO GROUND OF 5 OHMS THROUGHOUT THE GROUNDING ELECTRODE SYSTEM.
- 5. GROUNDING ELECTRODE CONDUCTOR: PROVIDE MINIMUM #2 TINNED COPPER GROUNDING ELECTRODE CONDUCTOR FROM THE GROUND RING TO THE SERVICE ENTRANCE DISCONNECT SWITCH, PUMP CONTROL PANEL, RTU, SCADA SYSTEM ANTENNA TOWER, ELECTRICAL EQUIPMENT RACK END POSTS, AND FENCE. USE GROUND CLAMPS RATED FOR CONNECTIONS TO END POSTS AND FENCE POSTS. GROUND CLAMPS SHALL BE RATED FOR DIRECT BURIAL. INSTALL GROUNDING ELECTRODE CONDUCTORS IN 3/4" SCH 80 PVC CONDUIT SLEEVE FOR MECHANICAL PROTECTION.
- 6. THE CONTRACTOR SHALL REVIEW THE SCADA SYSTEM DETAILS AND SHALL MAKE ALL PROVISIONS REQUIRED FOR THE INSTALLATION OF THE SCADA SYSTEM RTU AND ANTENNA INCLUDING: SLEEVE FOR THE ANTENNA MAST, GROUND ROD FOR THE ANTENNA MAST, RTU POWER AND CONTROL CONDUITS, FORCE MAIN PRESSURE TRANSMITTER CONDUIT, AND THE WATER MAIN PRESSURE TRANSMITTER STATIC WATER LINE.
- 7. THE TOP OF THE GROUND ROD FOR THE SCADA SYSTEM ANTENNA SHALL EXTEND NO MORE THAN 6" AND NO LESS THAN 4" ABOVE THE CONCRETE SLAB.

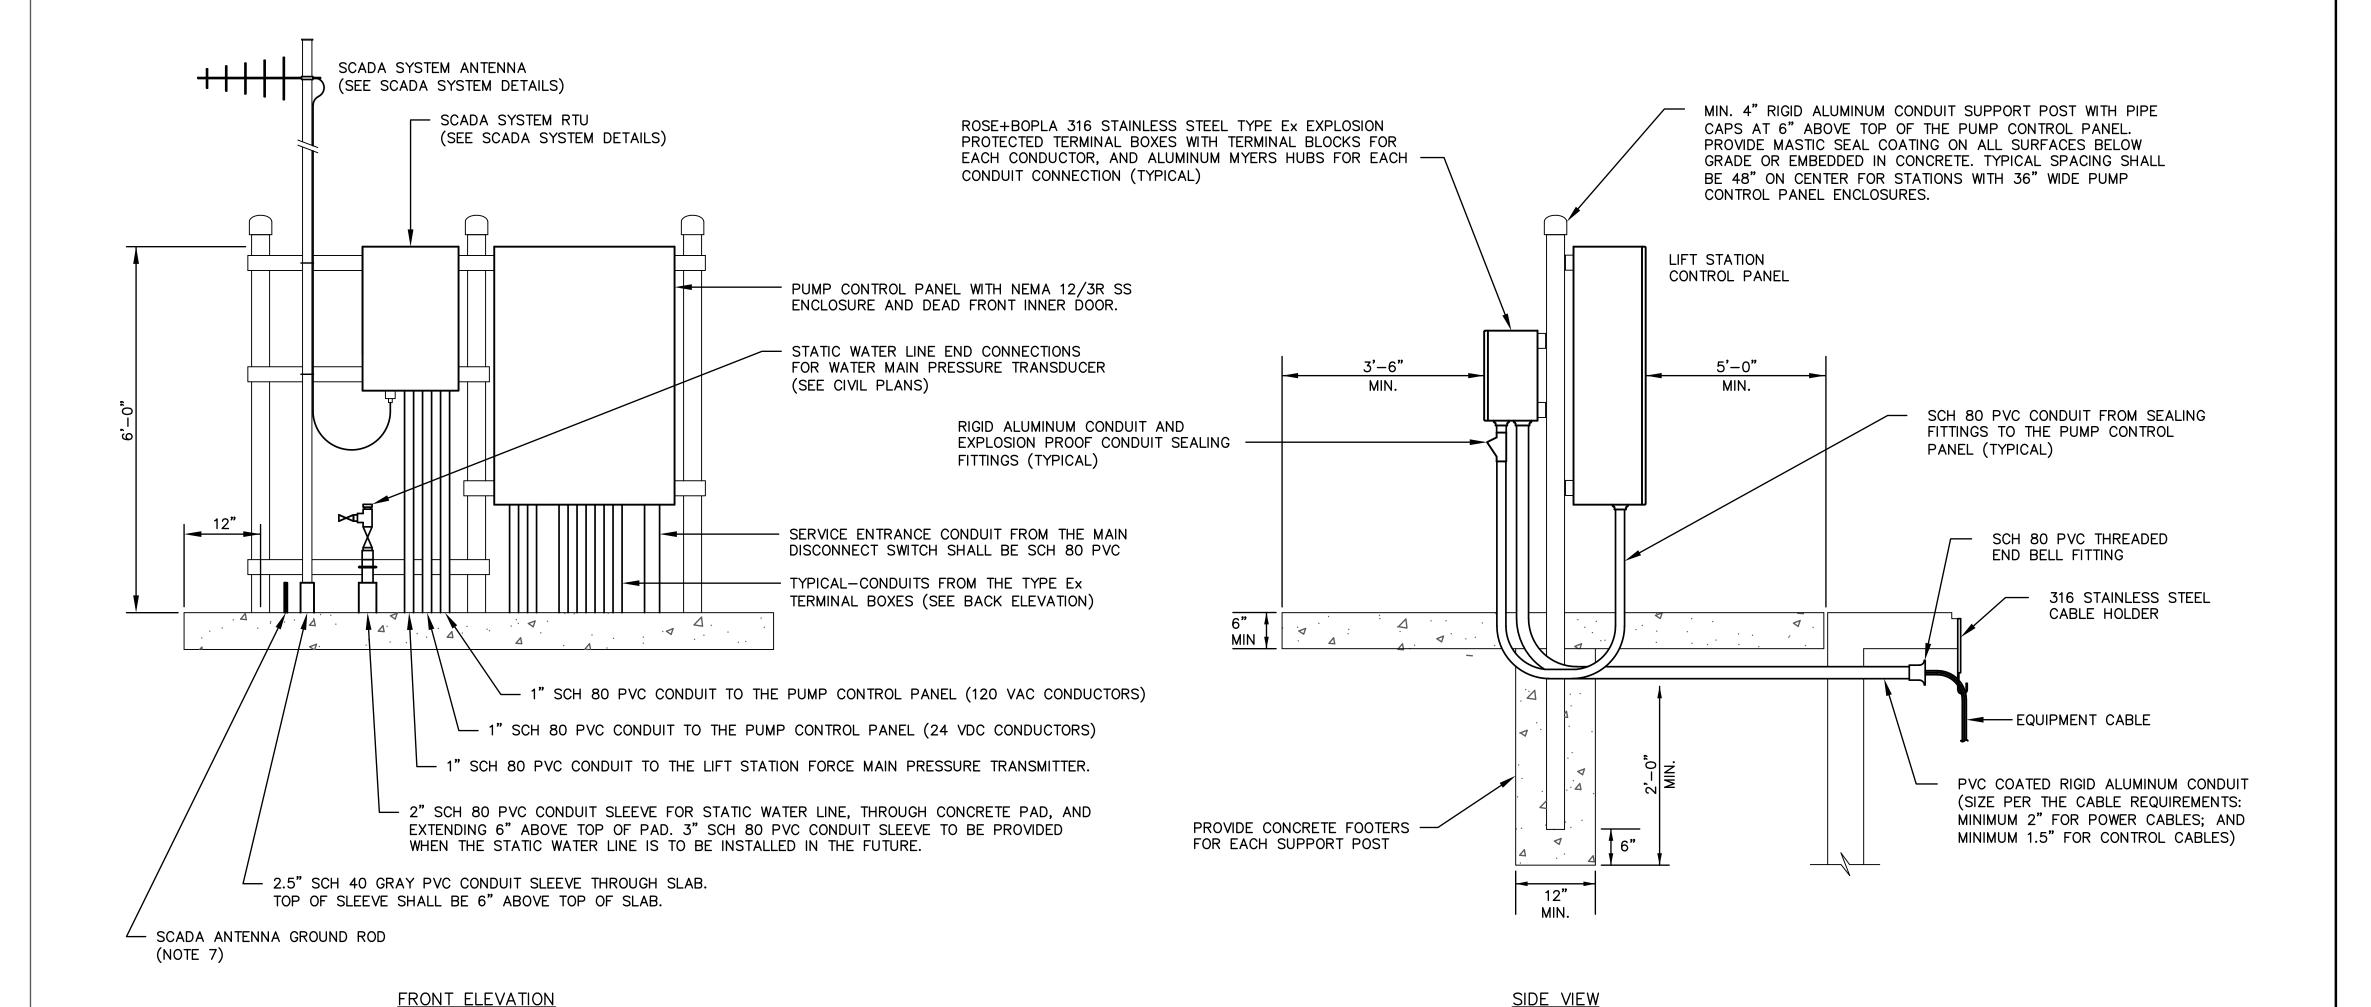

SERVICE ENTRANCE MAIN DISCONNECT SWITCH #1/0 TINNED COPPER EXTEND #2 TINNED COPPER GROUND RING GROUNDING ELECTRODE CONDUCTOR FROM THE GROUND RING AND BOND TO THE NEAREST FENCE POST TERMINAL BOXES SERVICE METER TYPICAL GROUND ROD (MIN. 3/4" DIAMETER, 20' PUMP CONTROL ANTENNA PANEL GROUND ROD (NOTE 7) TYPICAL BOND TO THE CONCRETE PAD REBAR 20' MIN.

ELECTRICAL EQUIPMENT GROUNDING SYSTEM DETAIL

NOT TO SCALE

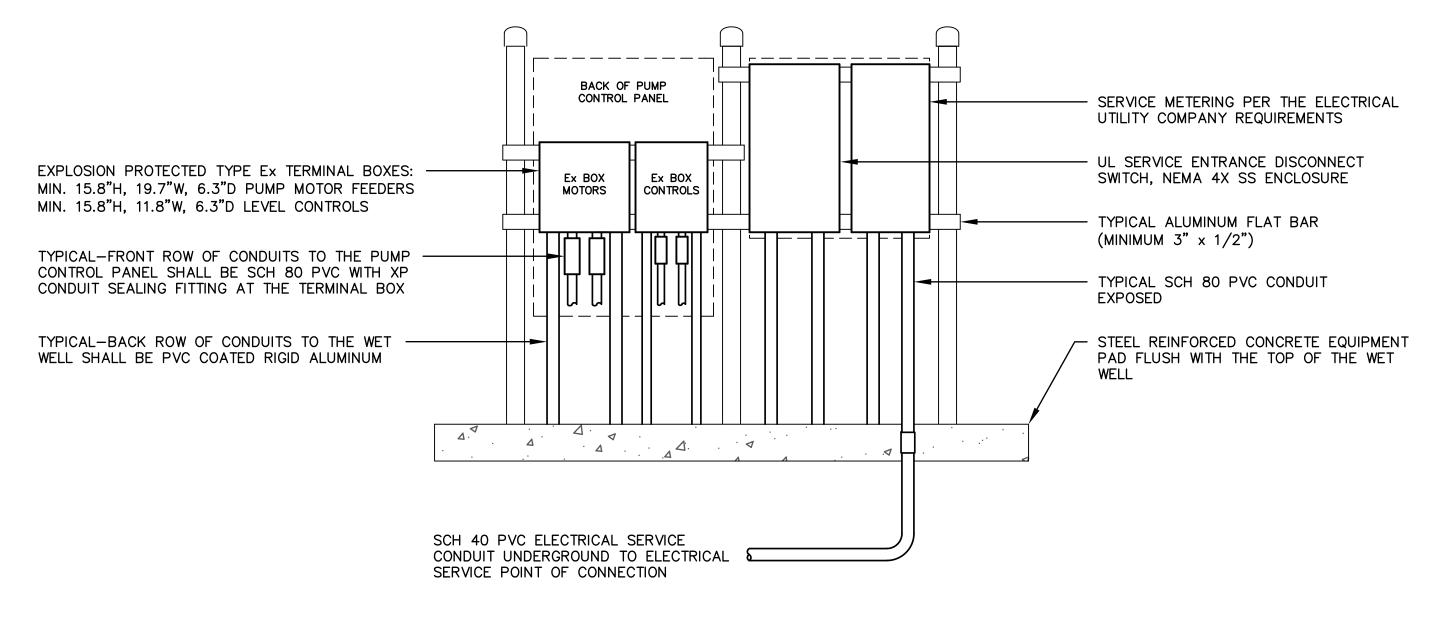

BACK ELEVATION

TYPICAL LIFT STATION ELECTRICAL EQUIPMENT INSTALLATION DETAIL

NOT TO SCALE

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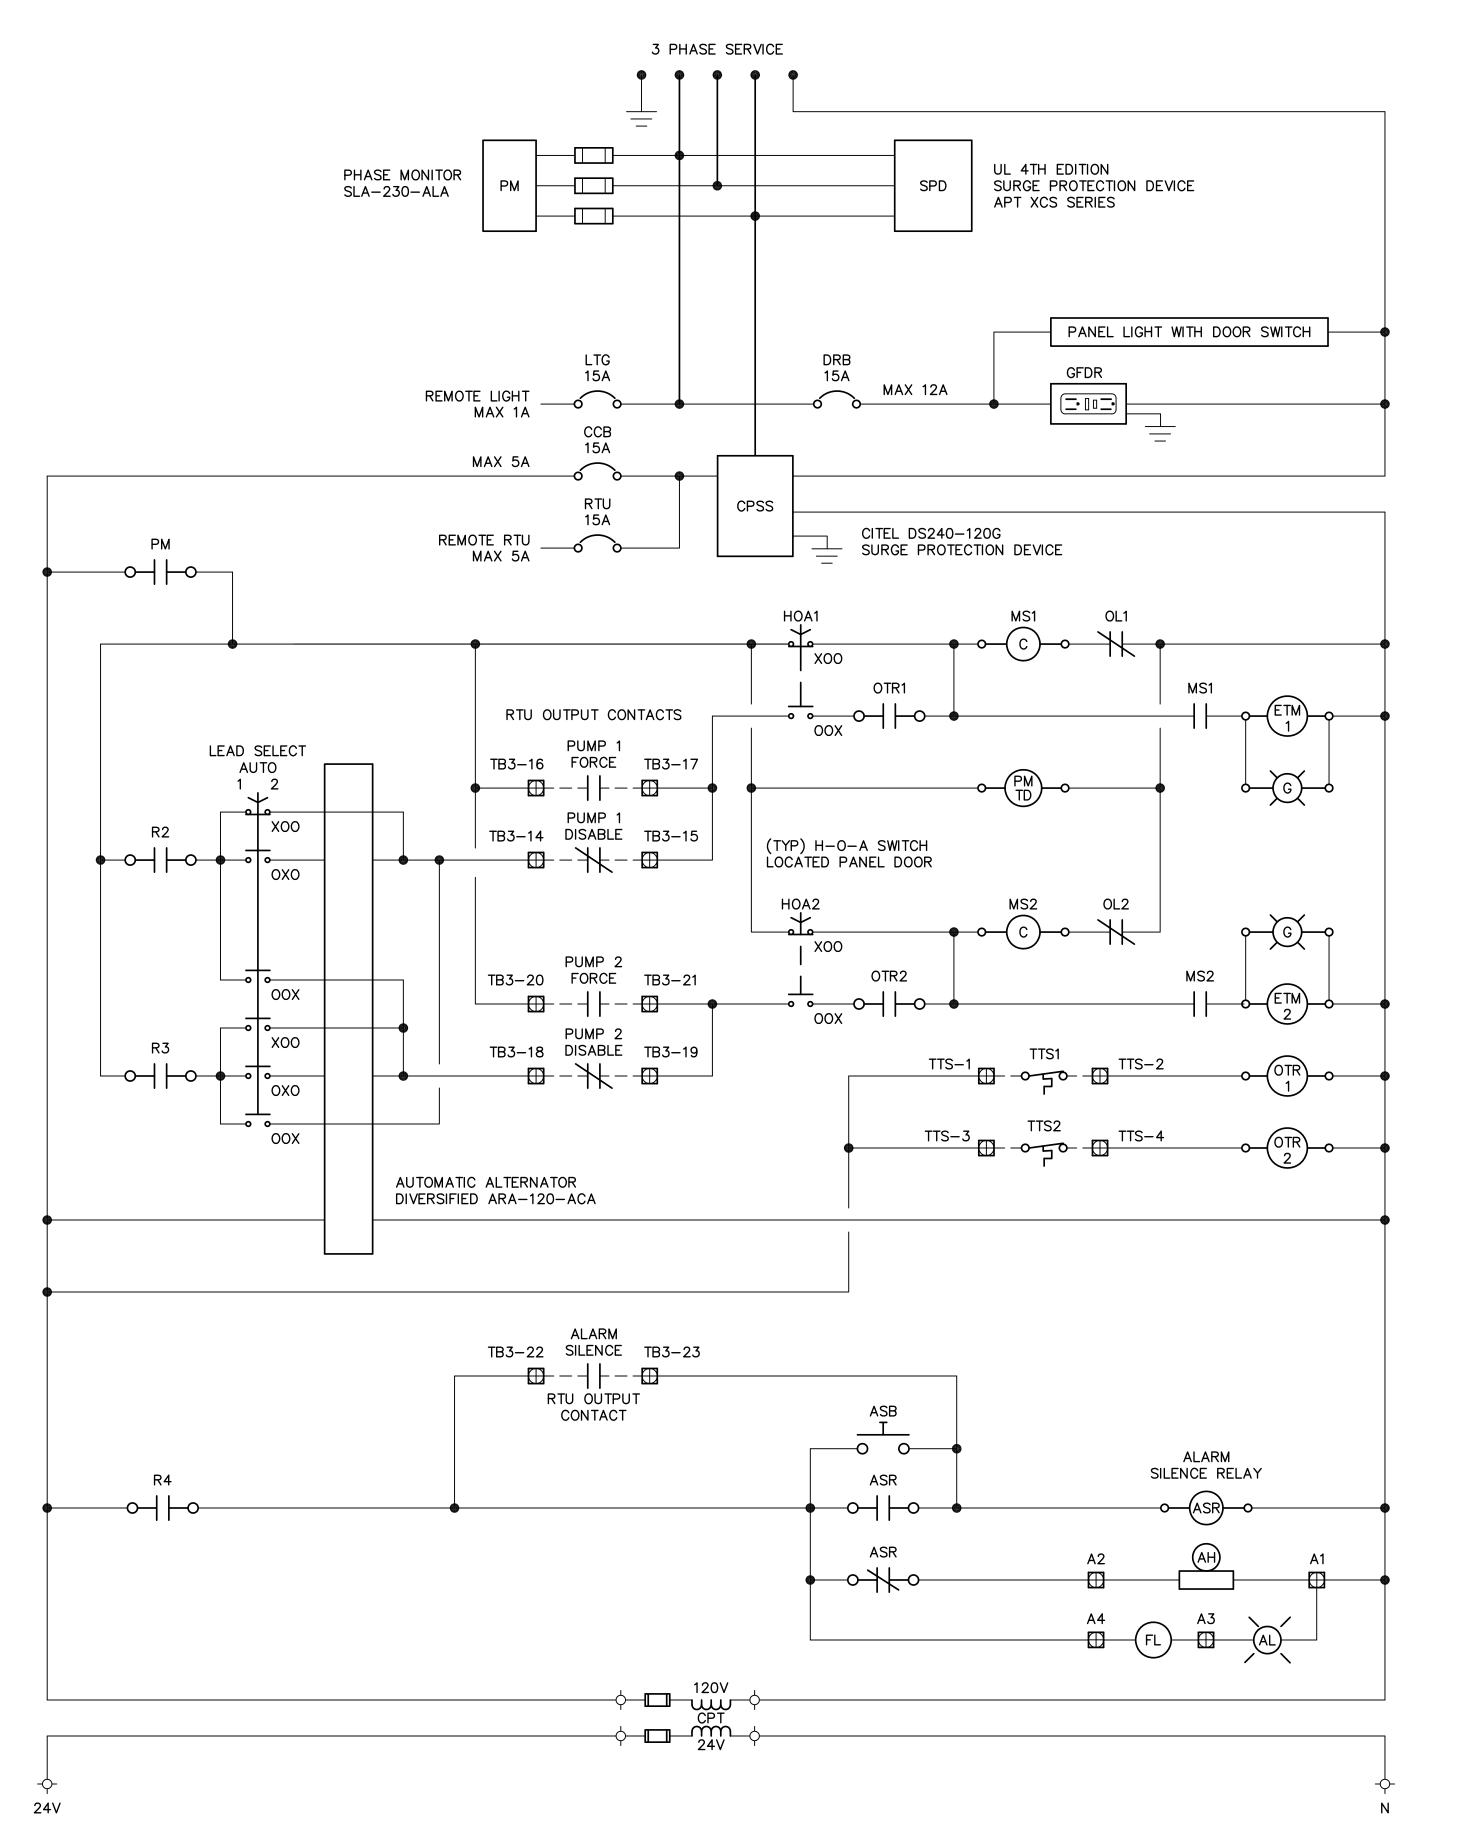
PINE LAKES PUMP STATION UPGRADE PROJECT
SJCUD STANDARD SUBMERSIBLE LIFT STATION
ELECTRICAL DETAILS


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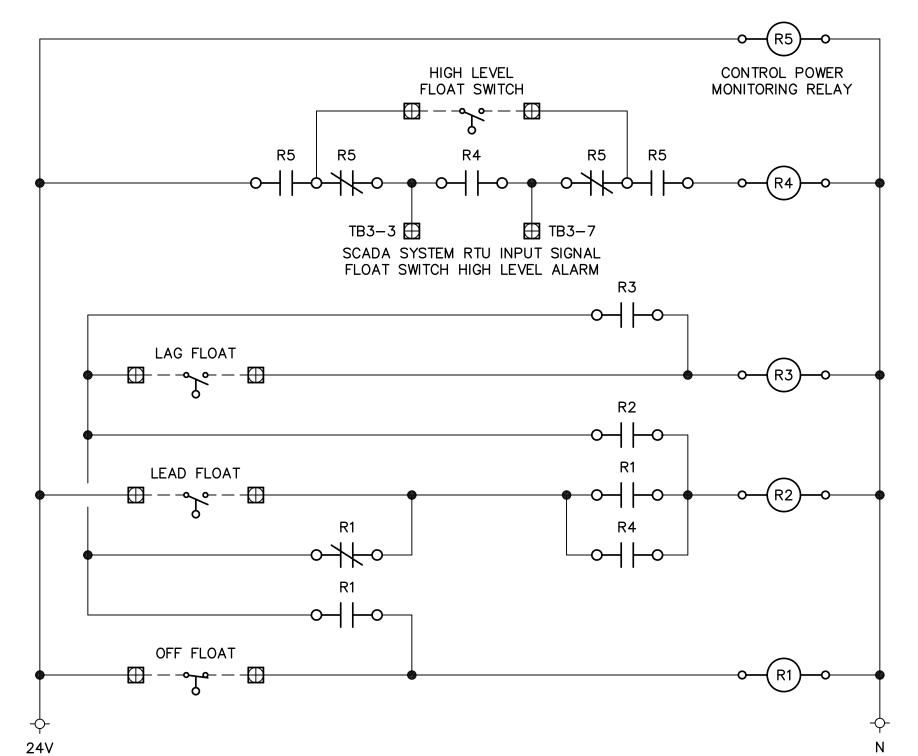




OUTER DOOR REMOVED TO SHOW DEADFRONT LAYOUT NEMA TYPE 12/3R S.S. ENCL. WITH CONTINUOUS HINGE ALL HARDWARE STAINLESS STEEL, WITH 3-PT LATCH

NOTES:


- CONTROL PANEL TO BE UL AND SERVICE ENTRANCE RATED.
- 2. ALL CONTROL PANEL WIRING, RTU WIRING, AND ALL WIRING FROM THE CONTROL PANEL TO THE RTU, SHALL BE TINNED CONDUCTORS.
- 3. ALL CONTROL RELAYS SHALL BE TPDT.
- 4. POWER MONITOR TIME DELAY RELAY "PMTD" SHALL BE EATON TMR6 TIME DELAY ON DE-ENERGIZE RELAY PROVIDING OFF DELAY FUNCTION WITHOUT REQUIRING INPUT VOLTAGE DURING OFF TIME DELAY. SET OFF TIME DELAY AT 60 SECONDS.
- 5. FIELD TERMINAL BLOCKS SHALL BE ANGLE MOUNTED TO FACILITATE FIELD CONNECTIONS.
- 6. TERMINALS FOR PUMP CONTROLS (RTU OUTPUTS, 120VAC) TB3-14 THRU TB3-23 SHALL BE COLOR CODED RED. TERMINALS FOR SCADA SIGNALS (RTU INPUTS, 24VDC) TB3-3 THRU TB3-13 SHALL BE COLOR CODED BLUE.

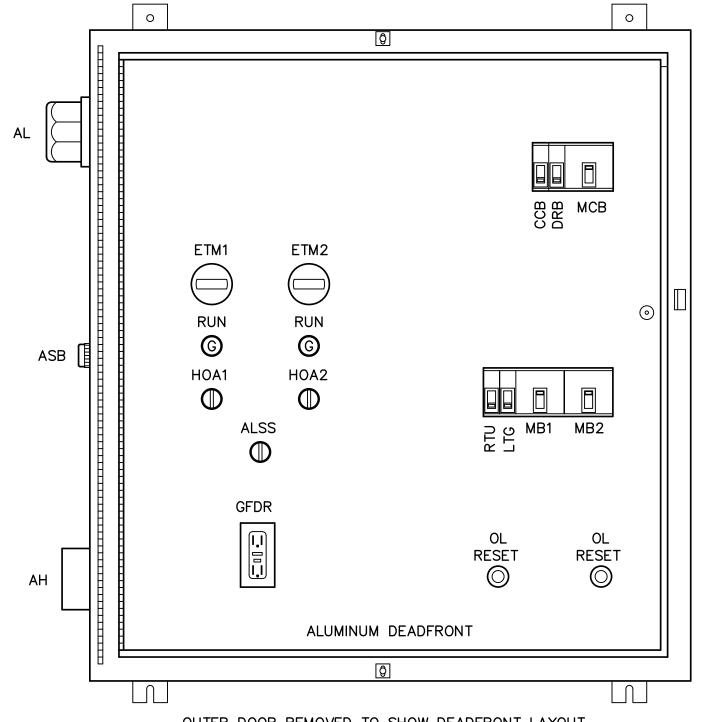

CONTROL PANEL LEGEND

- AH ALARM HORN
- AL ALARM LIGHT
- ASB ALARM SILENCE BUTTON ASR - ALARM SILENCE RELAY
- ALSS ALTERNATOR LEAD SELECTOR SWITCH
- CPSS CONTROL POWER SURGE SUPPRESSOR
- CB CONTROL CIRCUIT BREAKER
- DPDT DOUBLE POLE DOUBLE THROW
- DRB DUPLEX RECEPTACLE BREAKER
- TTM ELAPSED TIME METER
- F FUSE
- FB FUSE BLOCK
- FL FLASHER
- GREEN LED "RUNNING" PILOT LIGHT
- GFDR GROUND FAULT DUPLEX RECEPTACLE
- LCB LIGHTING CIRCUIT BREAKER
- MB MOTOR BREAKER
- MCB MAIN CIRCUIT BREAKER
- MS MOTOR STARTER
- OL OVERLOAD
- OT OVERTEMP
- PB POWER BLOCK
- PM PHASE MONITOR
- R RELAT
- RCB RTU CIRCUIT BREAKER
- RL RUNNING LIGHT
- SPD SURGE PROTECTION DEVICE
- B TERMINAL BLOCK
- S THERMAL TERMINAL STRIP

SCADA SYSTEM RTU INPUT SIGNALS

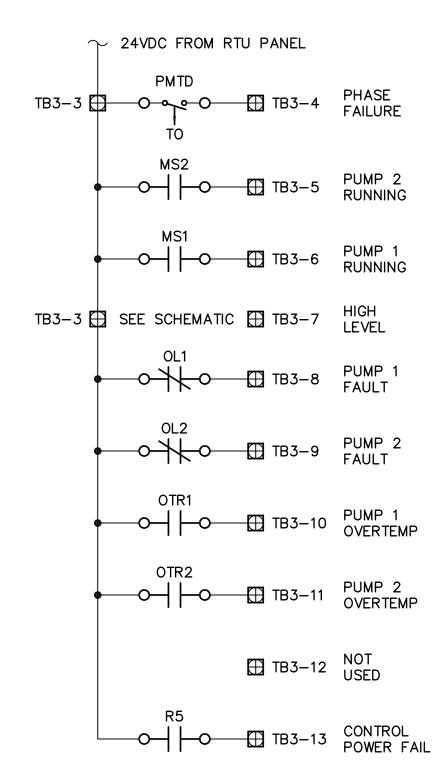

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PINE LAKES PUMP STATION UPGRADE PROJECT
SJCUD STANDARD SUBMERSIBLE LIFT STATION
PUMP CONTROL PANEL DETAILS

PROJECT NO. 100408.29


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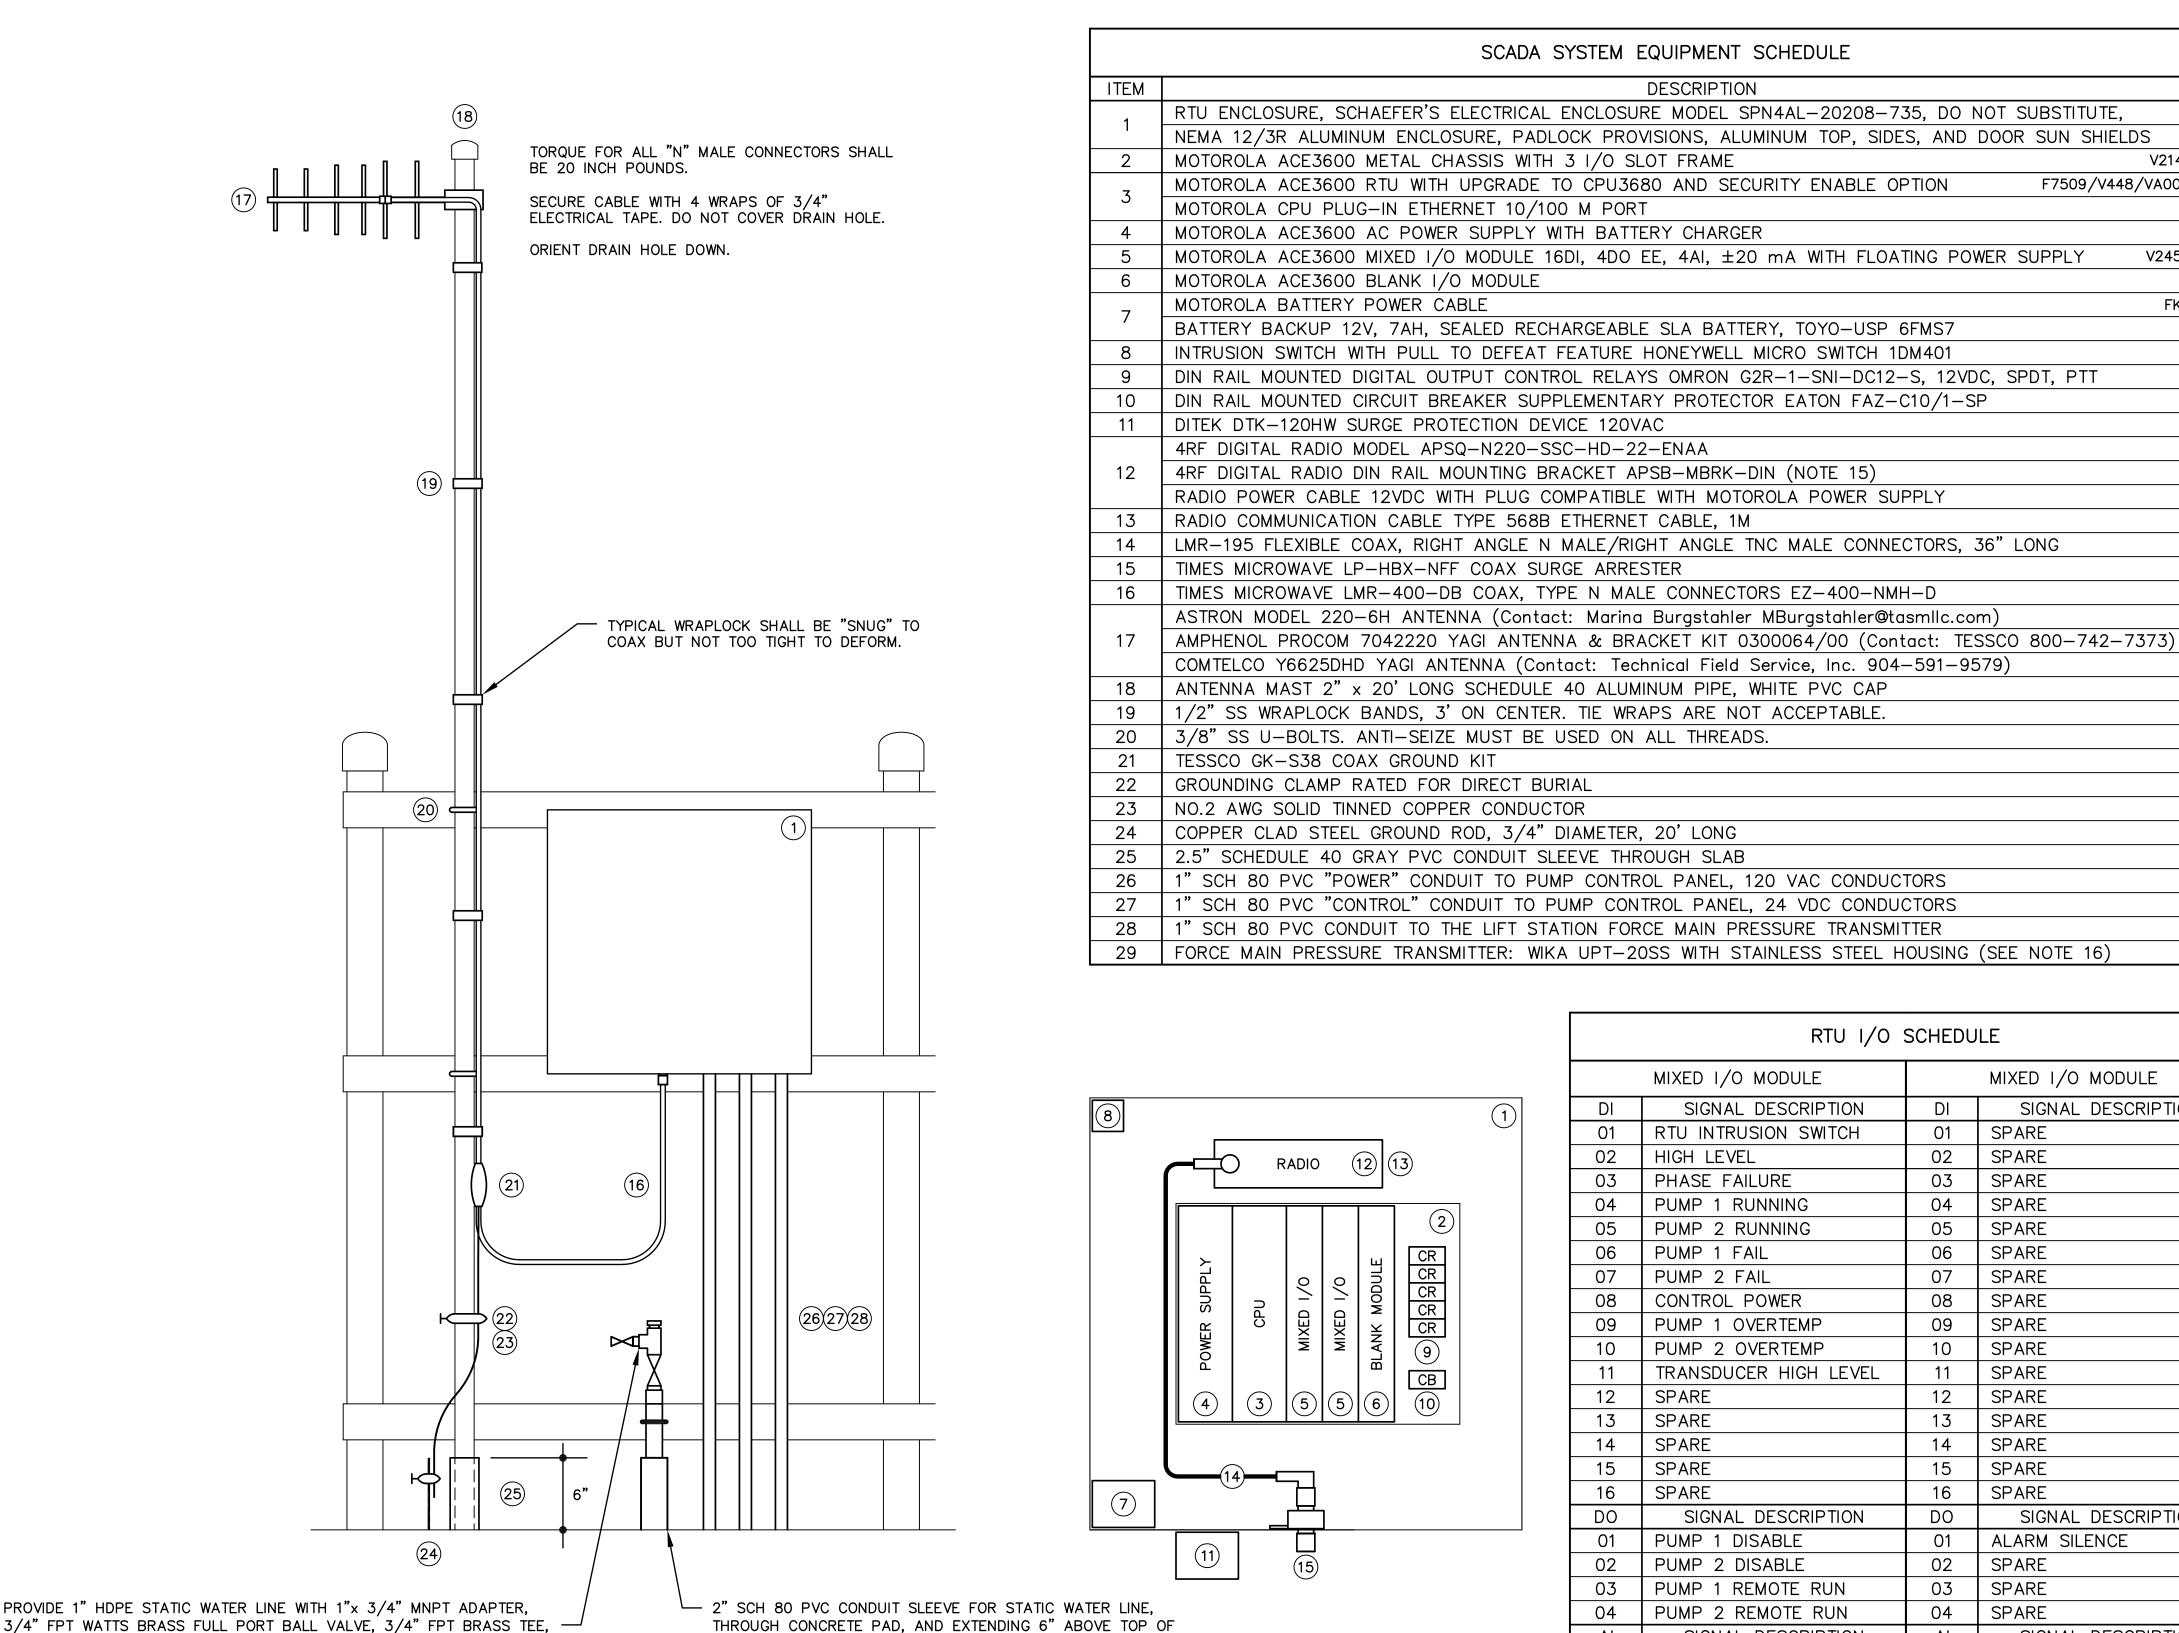
SCADA SYSTEM NOTES:

- THE CONTRACTOR SHALL EMPLOY THE SERVICES OF A SJCUD PRE-APPROVED SCADA SYSTEM INTEGRATOR TO PERFORM ALL SCADA SYSTEM ADDITIONS AND MODIFICATIONS INCLUDING: NEW RTU, ANTENNA, AND ANTENNA MAST.
- 2. THE SCADA SYSTEM SUPPLIER SHALL MODIFY AND UPGRADE THE EXISTING SJCUD MASTER SCADA SYSTEM AS REQUIRED TO INCORPORATE THE NEW
- THE CONTRACTOR AND THE SCADA SYSTEM SUPPLIER SHALL COORDINATE ALL SCADA SYSTEM INSTALLATION WITH THE SJCUD SCADA SYSTEM SUPERVISOR.
- THE SCADA SYSTEM RTU SHALL BE A SJCUD STANDARD LIFT STATION RTU WITH MOTOROLA ACE3600 RTU CONFIGURED WITH MIXED I/O MODULES AS INDICATED. PROVIDE POWER AND SIGNAL LINE SURGE PROTECTION.
- PRIOR TO SHOP DRAWING SUBMITTALS, THE SCADA SYSTEM SUPPLIER SHALL CONFIRM RADIO/ANTENNA SELECTION WITH THE SJCUD SCADA SYSTEM
- IN ORDER TO MAINTAIN FCC PART 15 COMPLIANCE, ALL ANTENNA WORK MUST BE PERFORMED OR CERTIFIED BY AN FCC CERTIFIED TECHNICIAN. THE SJCUD SCADA SUPERVISOR WILL INSPECT AND CERTIFY (AT NO CHARGE) BUT WILL NOT PERFORM CORRECTIVE ACTIONS.
- ANTENNA MAST GROUND ROD SHALL BE BONDED (UNDERGROUND) TO THE STATION ELECTRICAL SYSTEM GROUNDING GRID.
- ALL GROUNDING CONDUCTORS SHALL HAVE AN EVEN SLOPE FROM POINT OF CONTACT TO THE GROUND ROD (NO 90° BENDS).
- ALL GROUND CONTACT POINTS SHALL BE PROTECTED BY AN ANTI-OXIDATION
- ALL RF CONNECTORS SHALL BE TIGHTENED TO MANUFACTURER SPECIFICATIONS. AND SHALL BE PROPERLY SEALED. COLD SHRINK IS NOT ACCEPTABLE.
- 11. DRAIN HOLES ON ANTENNAS MUST BE ORIENTED DOWN.
- 12. ALL THREADED CONNECTIONS, EXCEPT ANTENNA CONNECTIONS, SHALL BE PROTECTED WITH ANTI-SEIZE TREATMENT.
- 13. THE "POWER" CONDUIT FROM THE RTU TO THE PUMP CONTROL PANEL SHALL BE USED FOR ALL 120 VAC CONDUCTORS, INCLUDING THE RTU INPUT POWER AND THE DIGITAL OUTPUT CONDUCTORS.
- 14. THE "CONTROL" CONDUIT FROM THE RTU TO THE PUMP CONTROL PANEL SHALL BE USED FOR ONLY 24 VDC CONDUCTORS, INCLUDING THE DIGITAL INPUT SIGNAL CONDUCTORS AND THE ANALOG INPUT SIGNAL CABLES. PROVIDE 1TSP#18 CABLE FOR EACH ANALOG INPUT SIGNAL.
- PROVIDE DIN RAIL ON BACK PLANE AT THE RTU RADIO MOUNTING LOCATION FOR THE 4RF RADIO MOUNTING BRACKET. MOUNT THE DIN RAIL USING EXISTING TAPPED SCREW HOLES. DO NOT DRILL AND TAP NEW HOLES.
- THE SCADA SYSTEM SUPPLIER SHALL PROVIDE THE FORCE MAIN PRESSURE TRANSMITTER, INCLUDING ASHCROFT TYPE 330 FLUSH DIAPHRAGM SEAL, AND ALUMINUM M20x1.5 METRIC TO 1/2" NPT CONDUIT CONNECTION ADAPTER.



FORCE MAIN PRESSURE TRANSMITTER DETAIL

NOT TO SCALE

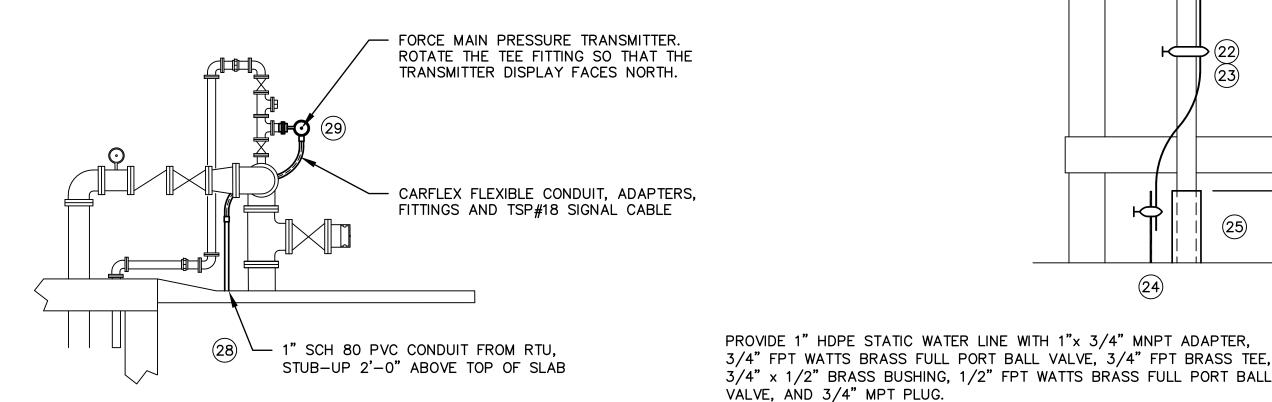

SCADA SYSTEM ANTENNA DETAIL

SCADA SYSTEM RTU DETAIL NOT TO SCALE

RADIO

CR

1" SCH 80 PVC CONDUIT TO THE LIFT STATION FORCE MAIN PRESSURE TRANSMITTER FORCE MAIN PRESSURE TRANSMITTER: WIKA UPT-20SS WITH STAINLESS STEEL HOUSING (SEE NOTE 16) RTU I/O SCHEDULE MIXED I/O MODULE MIXED I/O MODULE SIGNAL DESCRIPTION SIGNAL DESCRIPTION 01 SPARE RTU INTRUSION SWITCH 02 HIGH LEVEL 02 SPARE PHASE FAILURE 03 SPARE **SPARE** PUMP 1 RUNNING 04 05 **SPARE** PUMP 2 RUNNING 06 **SPARE** 06 PUMP 1 FAIL SPARE PUMP 2 FAIL **SPARE** 80 CONTROL POWER 80 I PUMP 1 OVERTEMP **SPARE** 09 SPARE PUMP 2 OVERTEMP 10 TRANSDUCER HIGH LEVEL **SPARE** 12 SPARE **SPARE** 13 SPARE SPARE 13 **SPARE** 14 SPARE 14 15 15 **SPARE** SPARE **SPARE** SPARE SIGNAL DESCRIPTION DO SIGNAL DESCRIPTION 01 01 ALARM SILENCE PUMP 1 DISABLE PUMP 2 DISABLE 02 SPARE SPARE | PUMP 1 REMOTE RUN 03

04

Αl

01

02

03

04

SPARE

SPARE

SPARE

SPARE

SPARE

SIGNAL DESCRIPTION

NOT TO SCALE

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	FEBRUARY 2020	DATE:					1.



W. DAVID LASSETTER, P.E

100 CENTER CREEK RD., STE 10 ST. AUGUSTINE, FL. 32084 H. 904-562-2185 CERTIFICATE OF AUTHORIZATIO

PAD. 3" CONDUIT SLEEVE TO BE PROVIDED WHEN THE STATIC

WATER LINE IS TO BE INSTALLED IN THE FUTURE.



PINE LAKES PUMP STATION UPGRADE PROJECT SJCUD STANDARD SUBMERSIBLE LIFT STATION SCADA SYSTEM DETAILS

PUMP 2 REMOTE RUN

FORCE MAIN PRESSURE

WATER MAIN PRESSURE

WET WELL LEVEL

SPARE

01

04

SIGNAL DESCRIPTION

SCADA SYSTEM EQUIPMENT SCHEDULE

4RF DIGITAL RADIO MODEL APSQ-N220-SSC-HD-22-ENAA

RADIO POWER CABLE 12VDC WITH PLUG COMPATIBLE WITH MOTOROLA POWER SUPPLY

DESCRIPTION

PROJECT NO. 100408.29 852E00P4.DW FILE NAME SHEET NO.

V214/V103

V245/V260

FKN8376

V261

F7509/V448/VA00360AA